


SCALE: 1/8" = 1'-0"

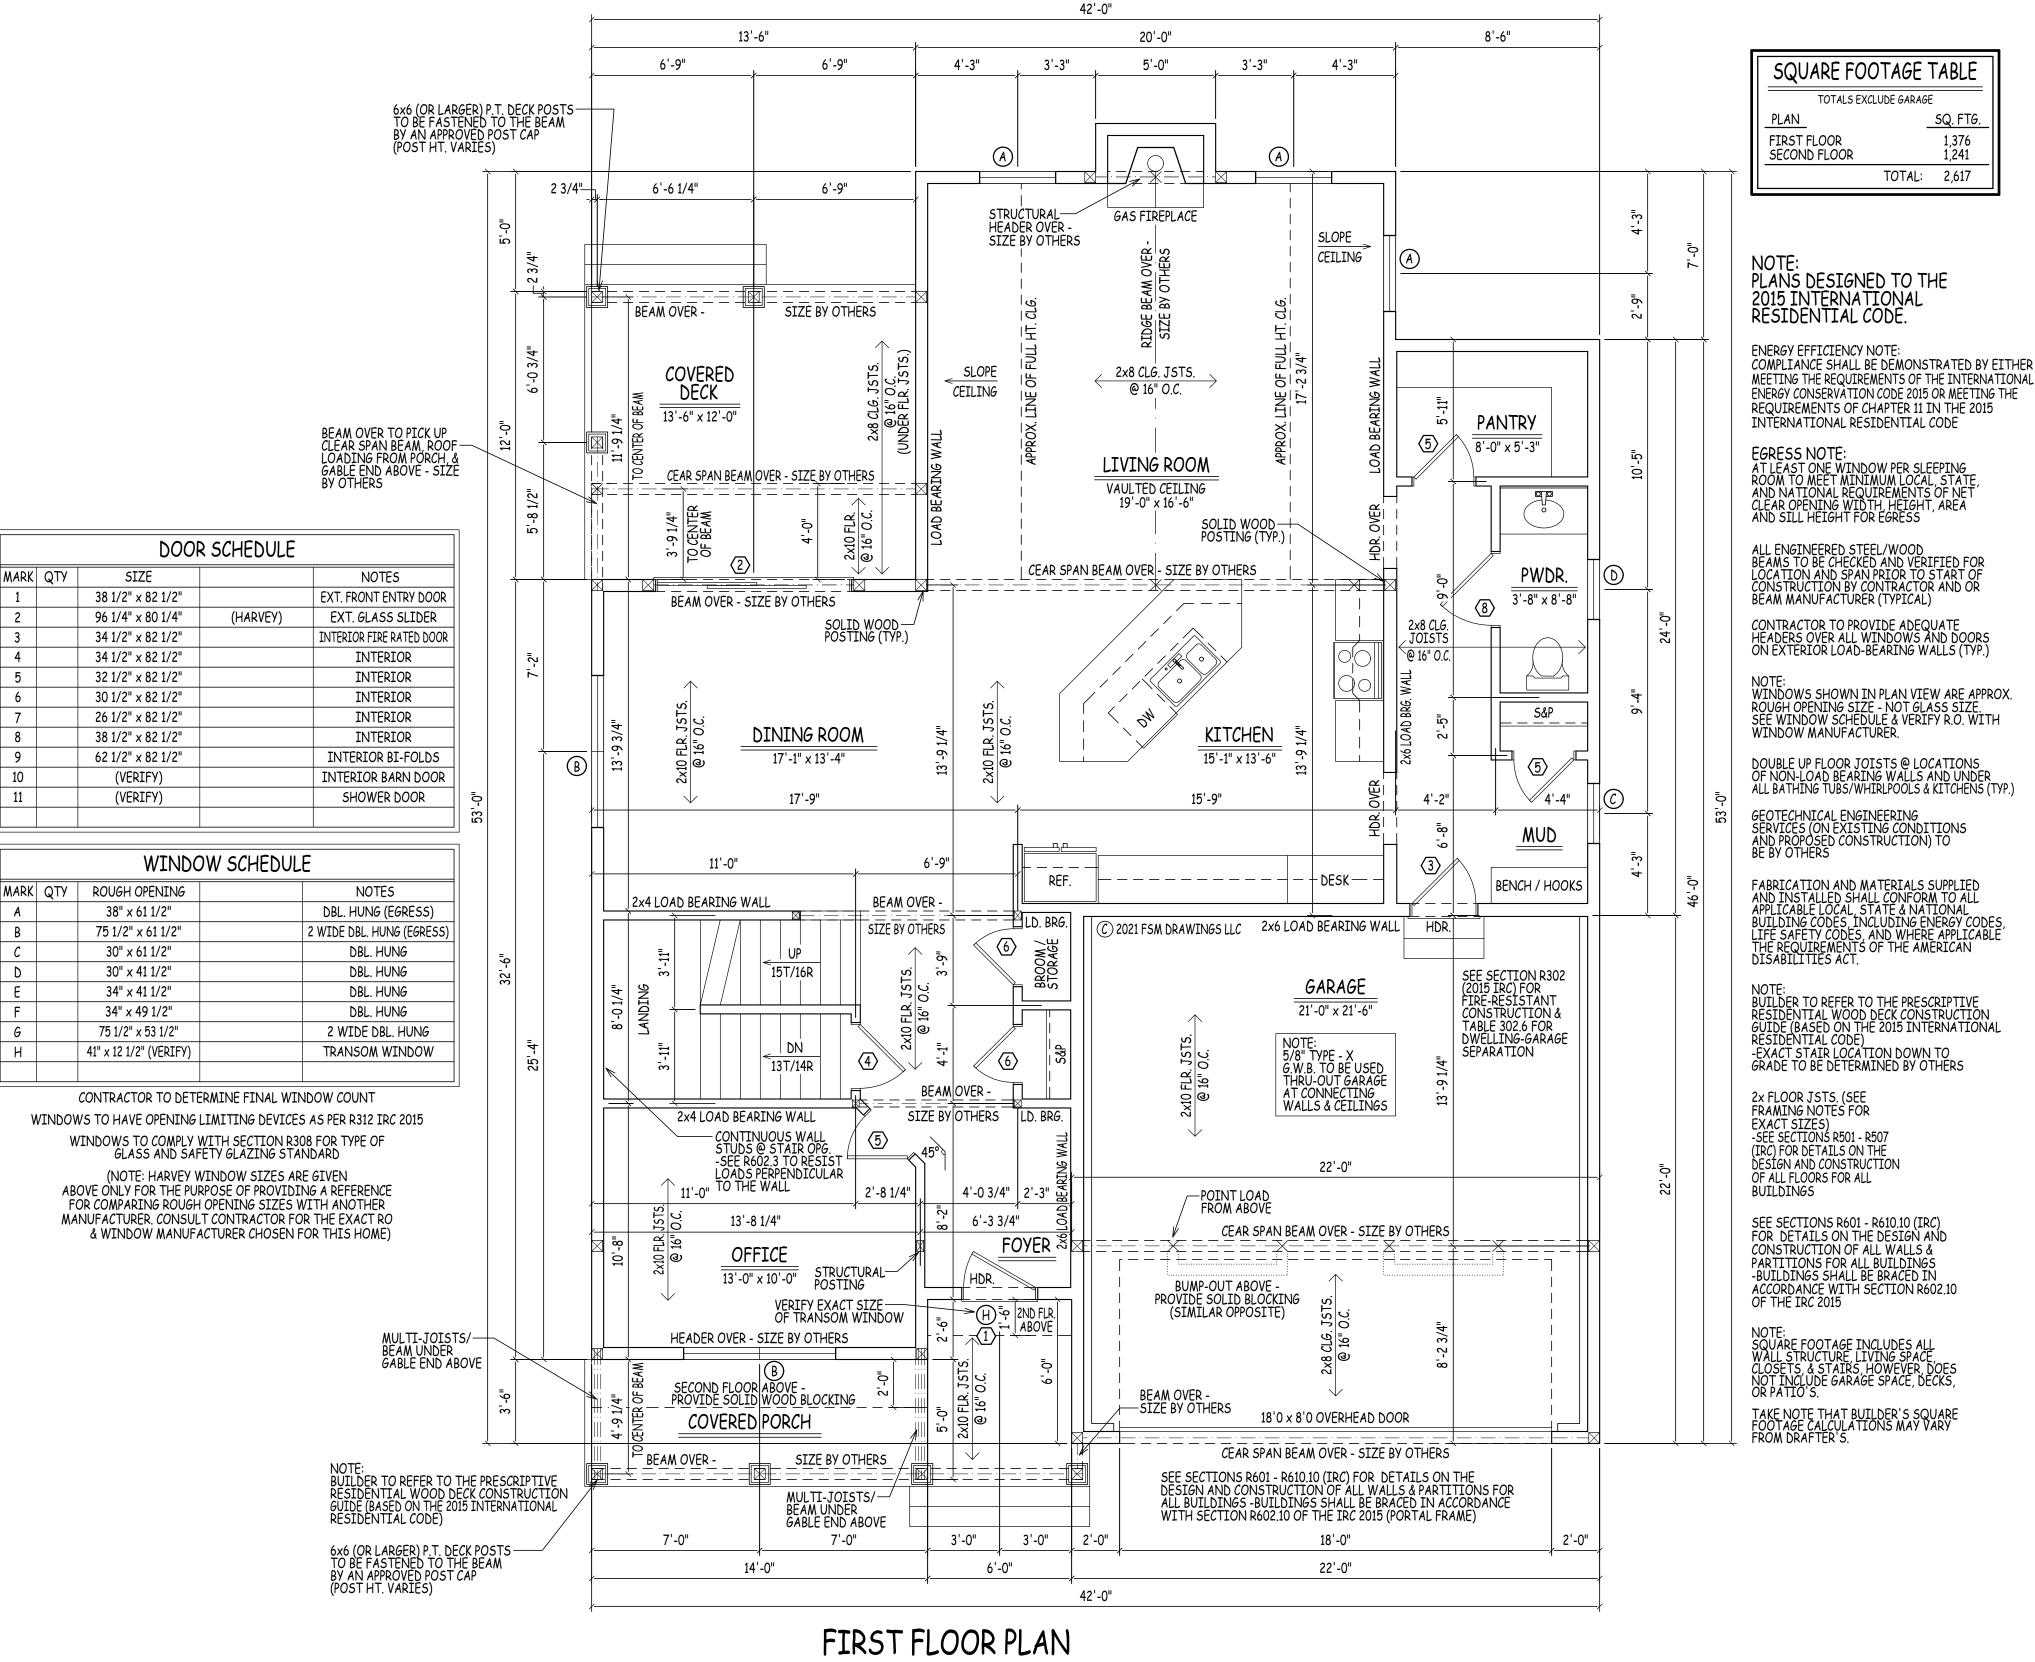

MODI LONDONDERRY NH S HOME 哭 ROAD OUNG

DRAWN BY: CHECKED BY: DHB DATE DRAWN: 12/07/21 DATE ISSUED: 12/07/2 SCALE: AS INDICATED JOB NO.: FSM21-205CS(R)



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25 BUTTRICK ROAD | UNIT A1 LONDONDERRY, NH 03053 TEL 603-965-0360 FAX 603-965-0361 WEB www.dhbhomes.com EMAIL bob@dhbhomes.com

ralphm@dht

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LONDONDERRY NH - MOD DHB HOMES LLC.

YOUNG ROAD PREPARED FOR:

DRAWN BY: AD

CHECKED BY: DHB

DATE DRAWN: 12/07/21

DATE ISSUED: 12/07/21

SCALE: AS INDICATED

JOB NO.: FSM21-205CS(R)


REVISIONS

NO. DATE REVISION

1 12/07/21 BASE PLAN MIRRORED; WORKING DRAWINGS ISSUED FOR REVIEW

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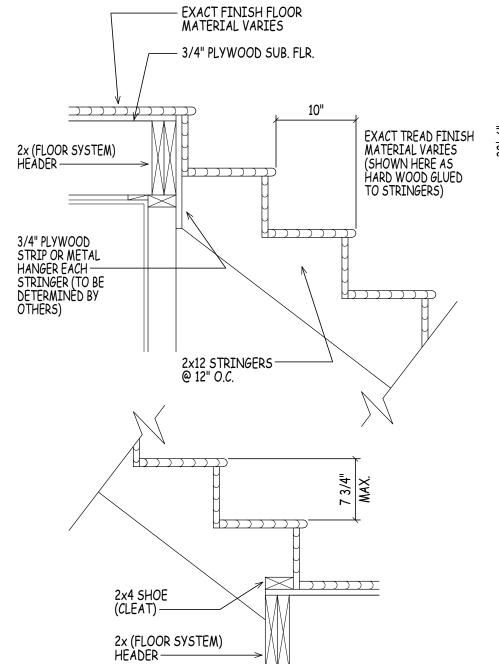


		WINDOW S	SCHEDULE
MARK	QTY	ROUGH OPENING	NOTES
Α		38" x 61 1/2"	DBL. HUNG (EGRESS)
В		75 1/2" x 61 1/2"	2 WIDE DBL. HUNG (EGRESS)
С		30" x 61 1/2"	DBL. HUNG
D		30" x 41 1/2"	DBL. HUNG
Е		34" x 41 1/2"	DBL. HUNG
F		34" x 49 1/2"	DBL. HUNG
G		75 1/2" x 53 1/2"	2 WIDE DBL. HUNG
Н		41" x 12 1/2" (VERIFY)	TRANSOM WINDOW

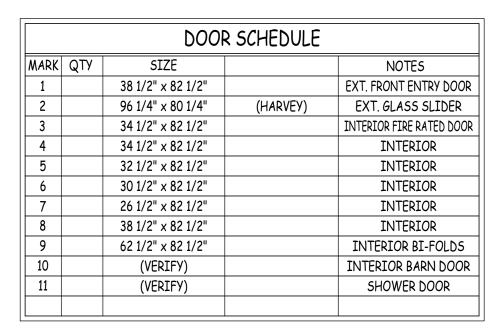CONTRACTOR TO DETERMINE FINAL WINDOW COUNT
WINDOWS TO HAVE OPENING LIMITING DEVICES AS PER R312 IRC 2015


WINDOWS TO COMPLY WITH SECTION R308 FOR TYPE OF GLASS AND SAFETY GLAZING STANDARD (NOTE: HARVEY WINDOW SIZES ARE GIVEN

(NOTE: HARVEY WINDOW SIZES ARE GIVEN
ABOVE ONLY FOR THE PURPOSE OF PROVIDING A REFERENCE
FOR COMPARING ROUGH OPENING SIZES WITH ANOTHER
MANUFACTURER. CONSULT CONTRACTOR FOR THE EXACT RO
& WINDOW MANUFACTURER CHOSEN FOR THIS HOME)



SIMILAR STAIR DETAILS

SCALE: 1" = 1'-0"

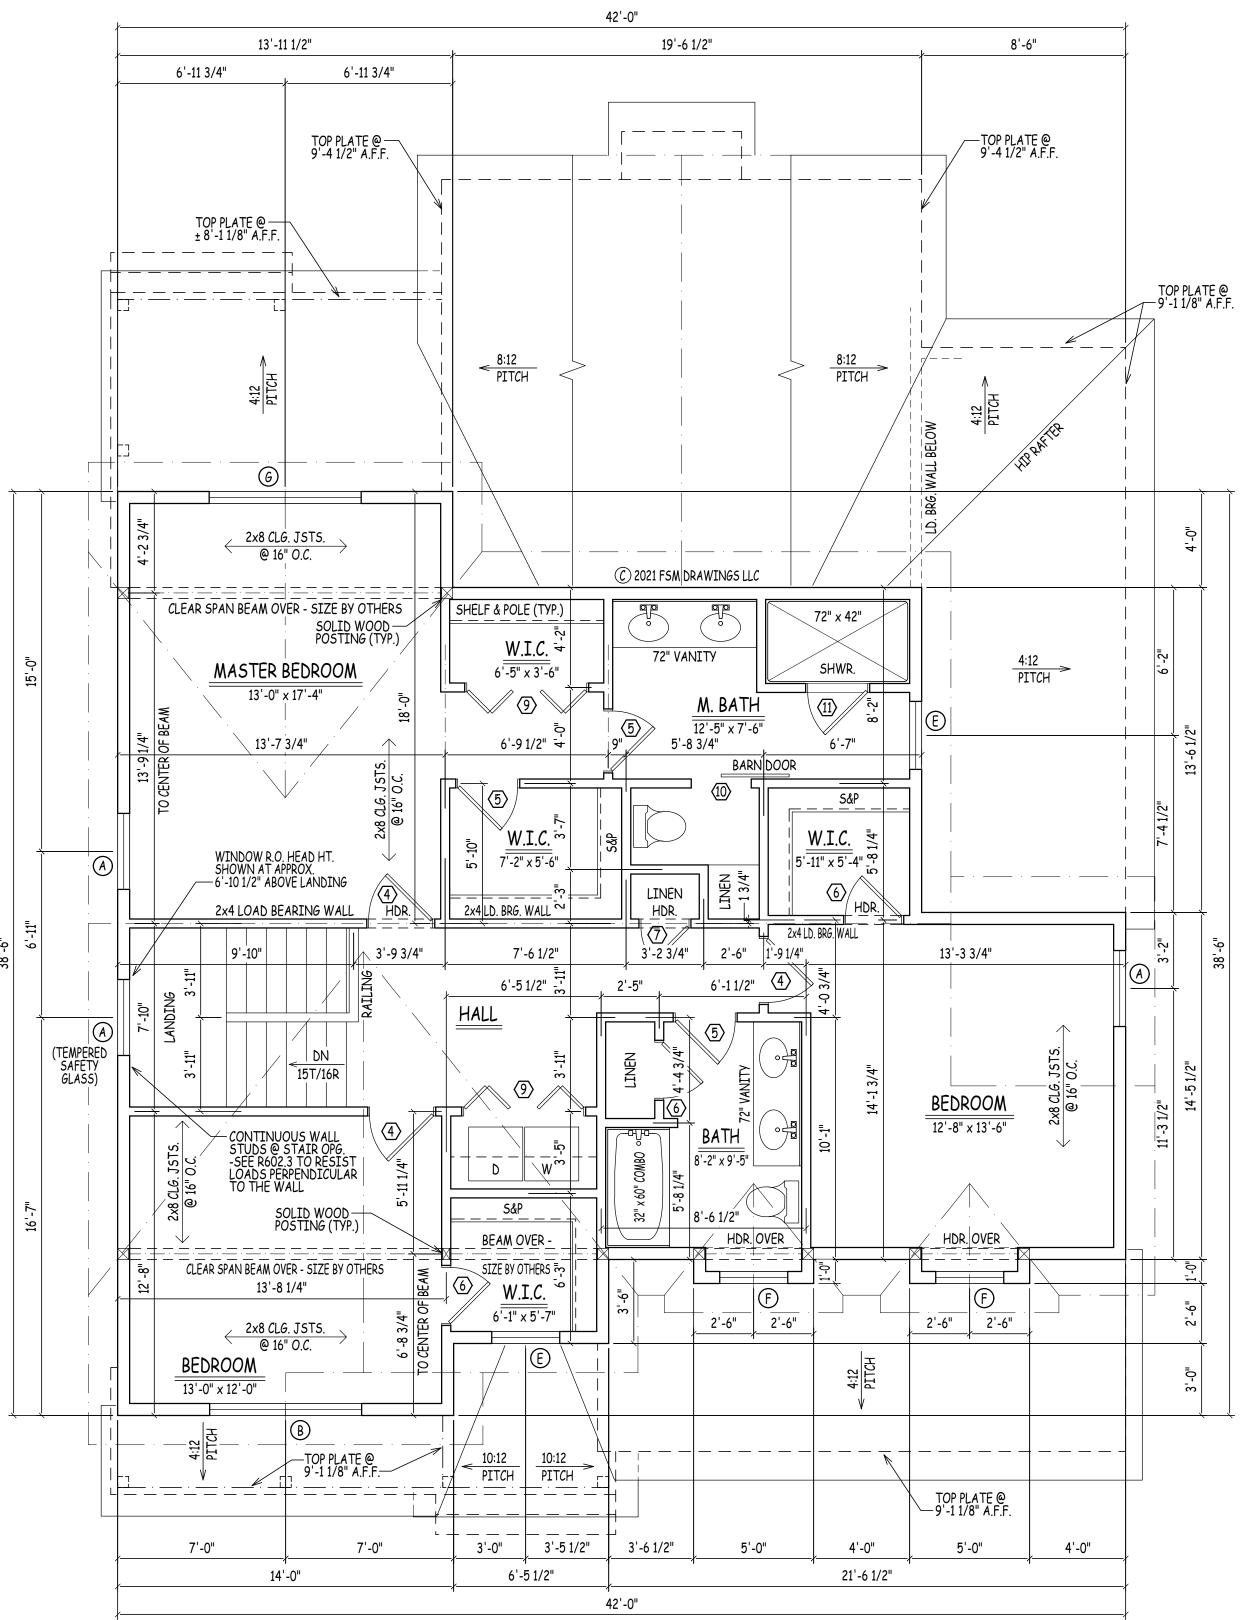

SQUARE FOOTAGE TABLE

TOTALS EXCLUDE GARAGE

PLAN

FIRST FLOOR
SECOND FLOOR

TOTAL: 2,617

NOTE: PLANS DESIGNED TO THE 2015 INTERNATIONAL RESIDENTIAL CODE.

ENERGY EFFICIENCY NOTE:
COMPLIANCE SHALL BE DEMONSTRATED BY EITHER
MEETING THE REQUIREMENTS OF THE INTERNATIONAL
ENERGY CONSERVATION CODE 2015 OR MEETING THE
REQUIREMENTS OF CHAPTER 11 IN THE 2015
INTERNATIONAL RESIDENTIAL CODE

EGRESS NOTE:
AT LEAST ONE WINDOW PER SLEEPING
ROOM TO MEET MINIMUM LOCAL, STATE,
AND NATIONAL REQUIREMENTS OF NET
CLEAR OPENING WIDTH, HEIGHT, AREA
AND SILL HEIGHT FOR EGRESS

ALL ENGINEERED STEEL/WOOD BEAMS TO BE CHECKED AND VERIFIED FOR LOCATION AND SPAN PRIOR TO START OF CONSTRUCTION BY CONTRACTOR AND OR BEAM MANUFACTURER (TYPICAL)

CONTRACTOR TO PROVIDE ADEQUATE HEADERS OVER ALL WINDOWS AND DOORS ON EXTERIOR LOAD-BEARING WALLS (TYP.)

NOTE: WINDOWS SHOWN IN PLAN VIEW ARE APPROX. ROUGH OPENING SIZE - NOT GLASS SIZE. SEE WINDOW SCHEDULE & VERIFY R.O. WITH WINDOW MANUFACTURER.

DOUBLE UP FLOOR JOISTS @ LOCATIONS OF NON-LOAD BEARING WALLS AND UNDER ALL BATHING TUBS/WHIRLPOOLS & KITCHENS (TYP.)

GEOTECHNICAL ENGINEERING SERVICES (ON EXISTING CONDITIONS AND PROPOSED CONSTRUCTION) TO BE BY OTHERS

FABRICATION AND MATERIALS SUPPLIED AND INSTALLED SHALL CONFORM TO ALL APPLICABLE LOCAL, STATE & NATIONAL BUILDING CODES, INCLUDING ENERGY CODES, LIFE SAFETY CODES, AND WHERE APPLICABLE THE REQUIREMENTS OF THE AMERICAN DISABILITIES ACT.

NOTE:
BUILDER TO REFER TO THE PRESCRIPTIVE
RESIDENTIAL WOOD DECK CONSTRUCTION
GUIDE (BASED ON THE 2015 INTERNATIONAL
RESIDENTIAL CODE)
-EXACT STAIR LOCATION DOWN TO
GRADE TO BE DETERMINED BY OTHERS

2x FLOOR JSTS. (SEE FRAMING NOTES FOR EXACT SIZES) -SEE SECTIONS R501 - R507 (IRC) FOR DETAILS ON THE DESIGN AND CONSTRUCTION OF ALL FLOORS FOR ALL BUILDINGS

SEE SECTIONS R601 - R610.10 (IRC) FOR DETAILS ON THE DESIGN AND CONSTRUCTION OF ALL WALLS & PARTITIONS FOR ALL BUILDINGS -BUILDINGS SHALL BE BRACED IN ACCORDANCE WITH SECTION R602.10 OF THE IRC 2015

NOTE: SQUARE FOOTAGE INCLUDES ALL WALL STRUCTURE, LIVING SPACE, CLOSETS, & STAIRS, HOWEVER, DOES NOT INCLUDE GARAGE SPACE, DECKS, OR PATIO'S.

KE NOTE THAT BUILDER'S SQUAI OTAGE CALCULATIONS MAY VARY OM DRAFTER'S.




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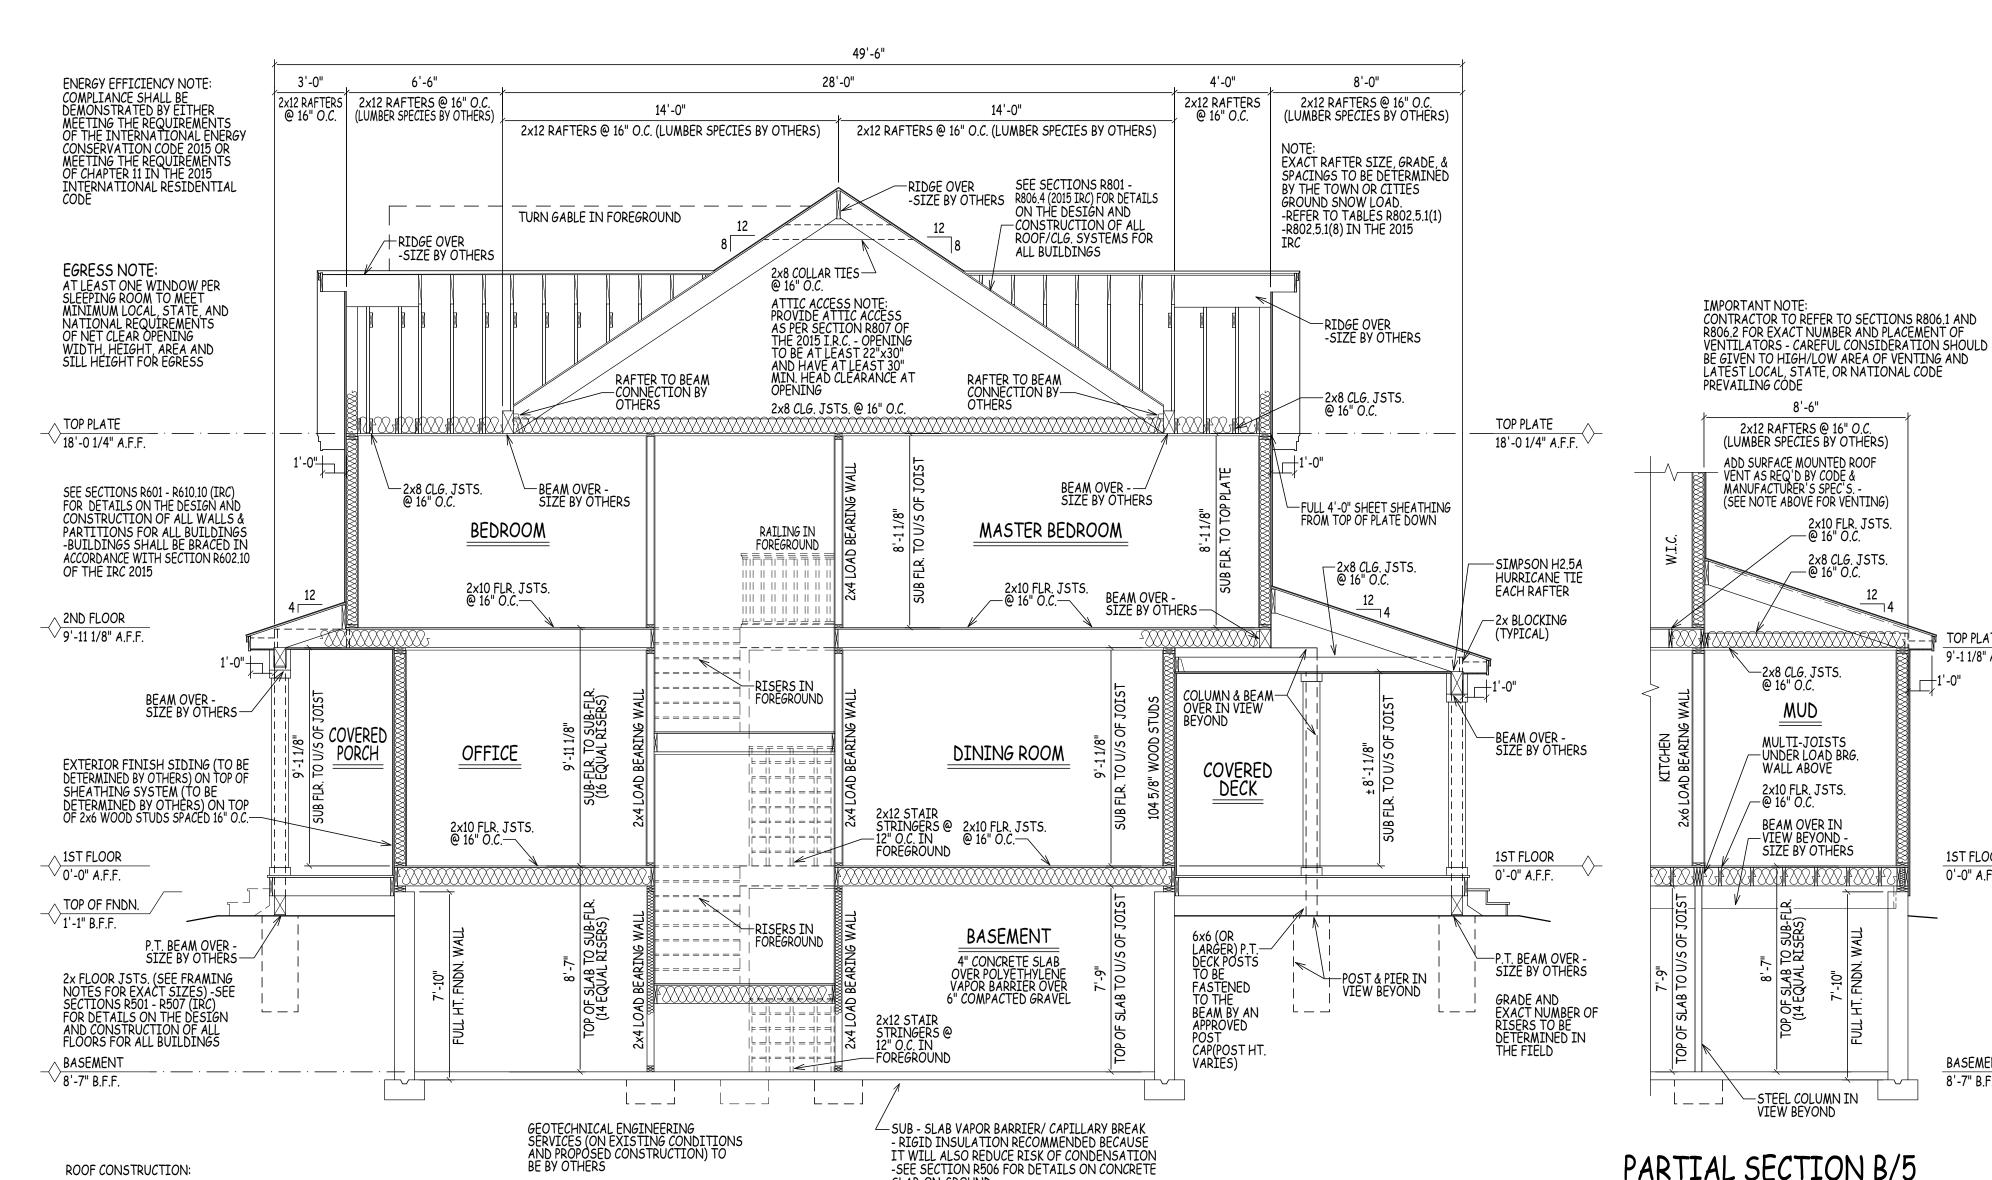
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TOP PLATE

1ST FLOOR 0'-0" A.F.F.

BASEMENT

8'-7" B.F.F.

SCALE: 1/4" = 1'-0"

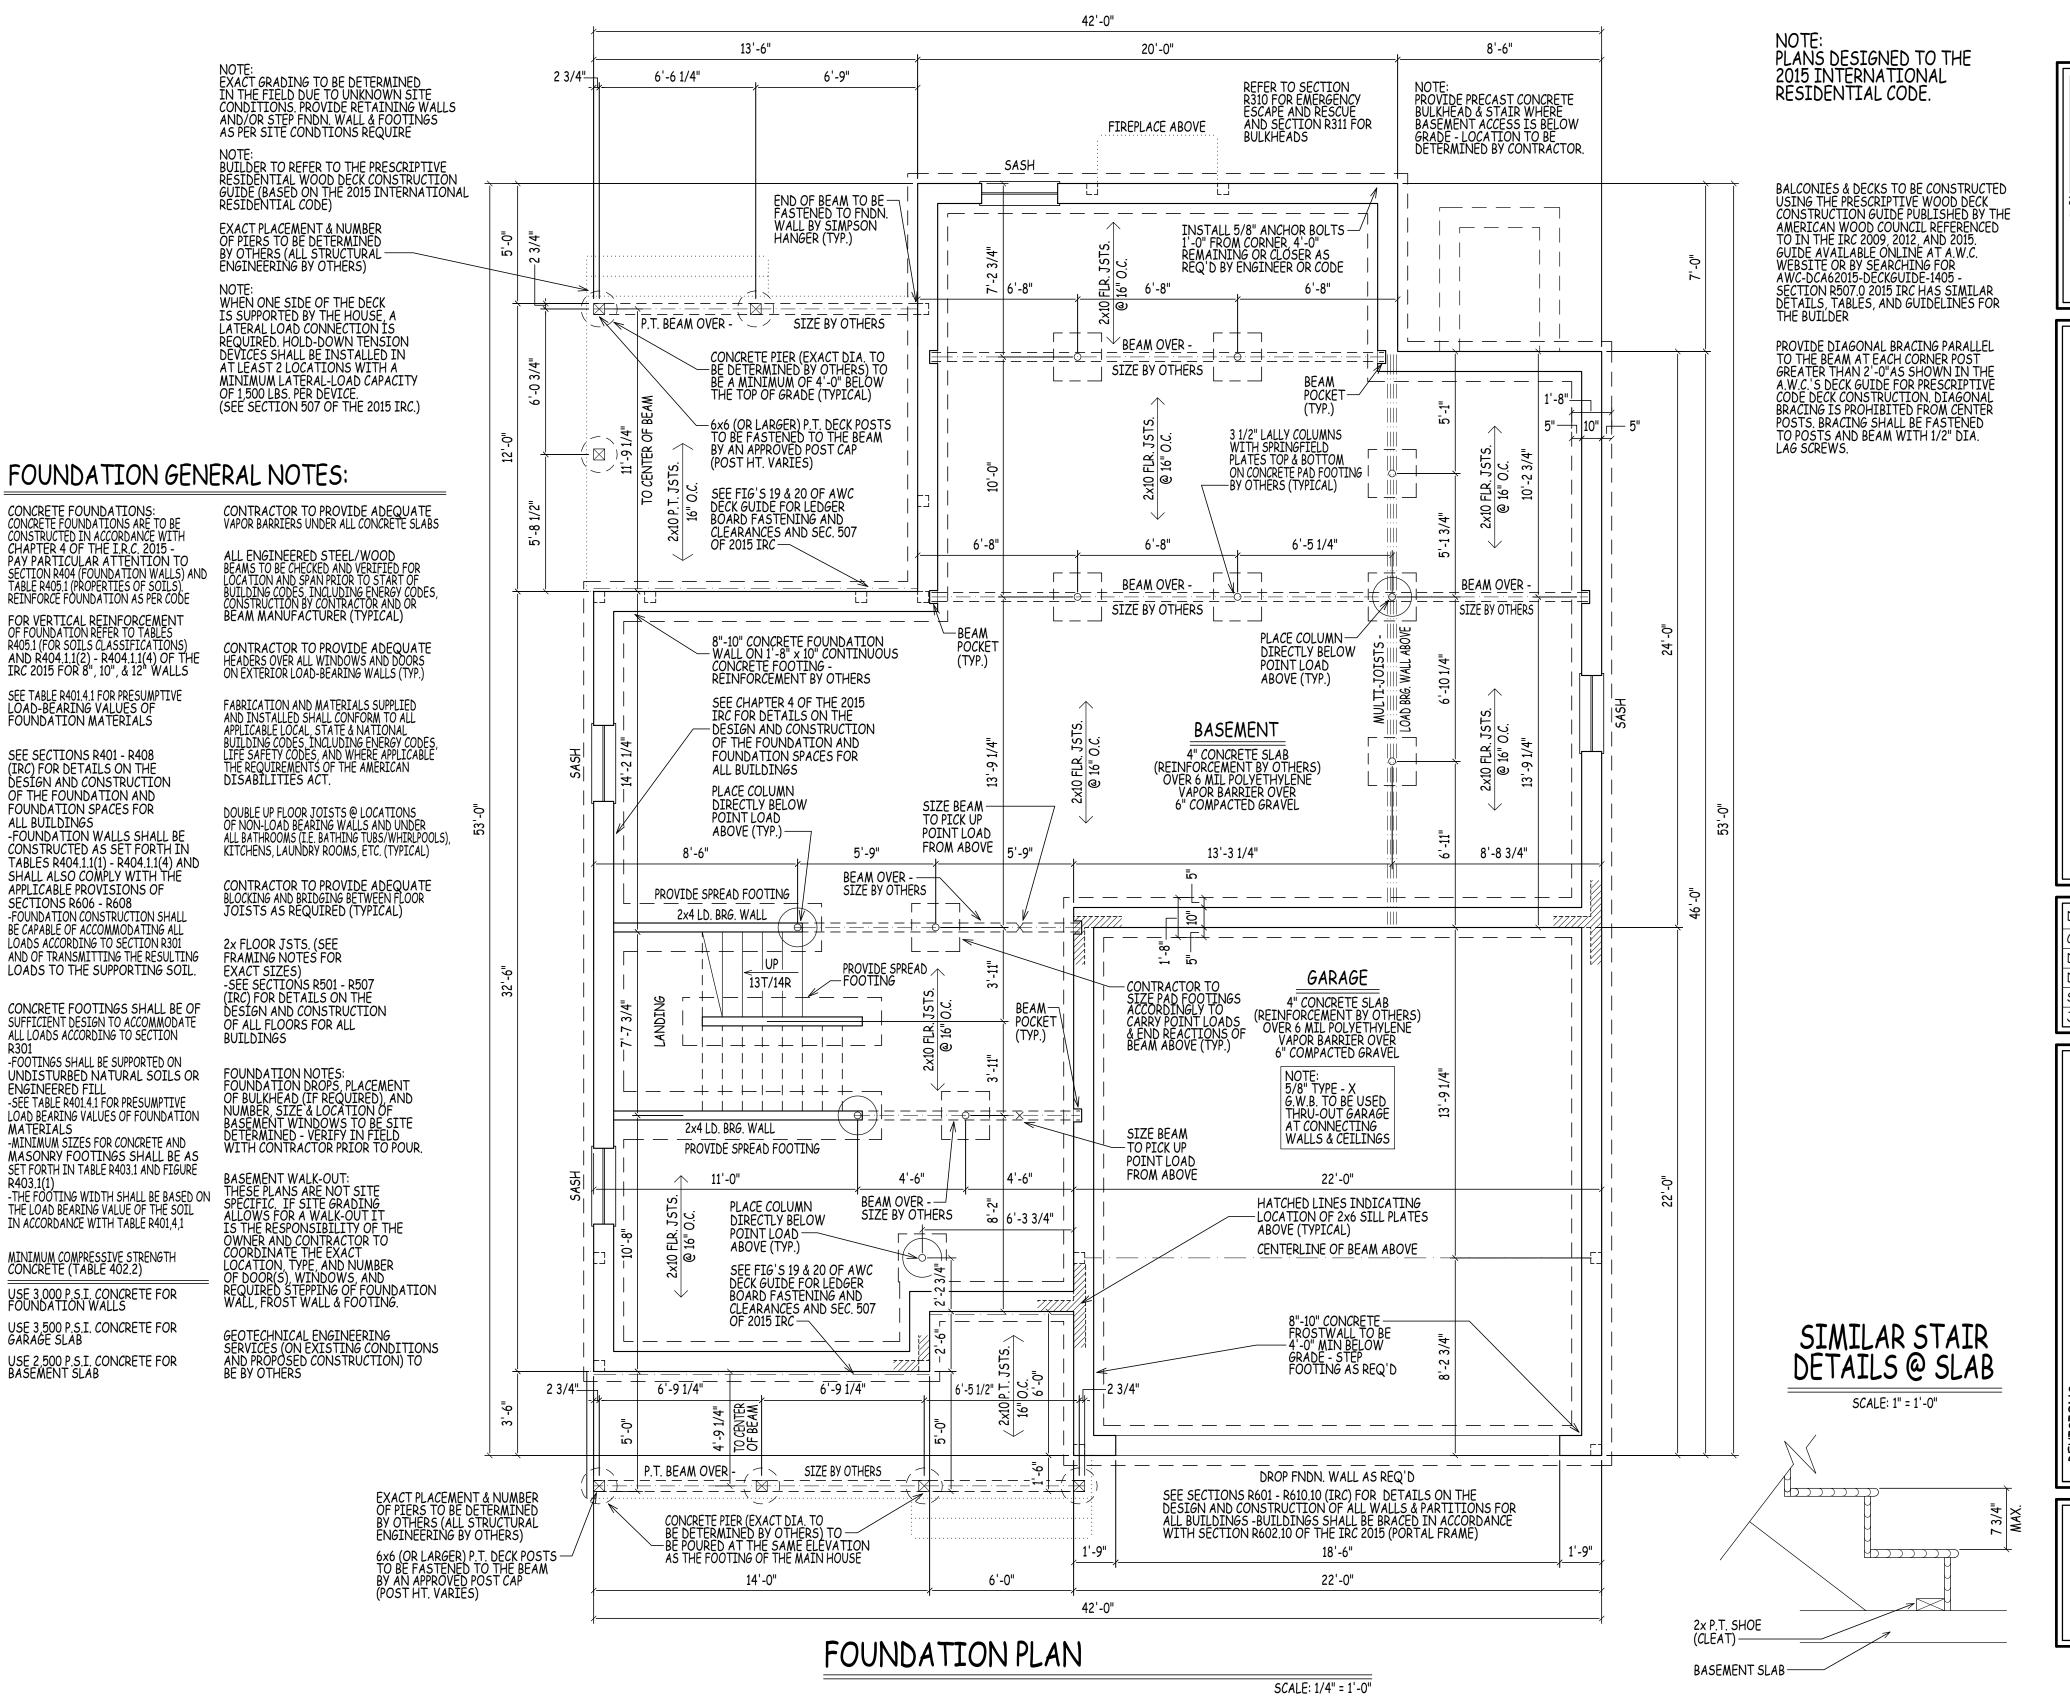+1'-0"

9'-1 1/8" A.F.F. ∨

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DHB HOMES

5 BUTTRICK ROAD | UNIT A

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FLOOR CONSTRUCTION:

2x10 FLOOR JOISTS @ 16" O.C. W/ 3/4" TONGUE & GROOVE PLYWD. GLUED & NAILED (TYP. U.O.N.) -SEE FLOOR PLANS FOR FRAMING DIRECTION/ SPACING NOTATION MARKERS

BUILT-UP BEAMS SIZED BY CONTRACTOR

DOUBLE UP FLOOR JOISTS @ LOCATIONS OF NON-LOAD BEARING WALLS AND UNDER ALL BATHING TUBS/WHIRLPOOLS & KITCHENS (TYP.)

INSULATION

R-20 CAVITY INSULATION OR R-13 PLUS R-5 (ZONE 5) R-20 CAVITY INSULATION PLUS R-5 OR R-13 PLUS R-10 (ZONE 6)

VALUE OVER THE PLATES (RAISED) R-38 (ZONE 5 & 6)

R-30 OR INSULATION SUFFICIENT TO FILL JOIST CAVITY FLOOR: R-49 (ZONE 5 & 6) - HOWEVER, IF MAINTAINING THE FULL R

MOISTURE VAPOR RETARDERS SHALL BE INSTALLED IN ACCORDANCE WITH THE REQUIREMENTS SET FORTH IN THE 2015 I.R.C. SECTIONS R318.1, AND R702.7 MOISTURE CONTROL

SCALE: 1/4" = 1'-0"

VERIFY RIDGE BOARD/BEAM SIZES IN FIELD

2 x 12 (MAIN BOX) RAFTERS @ 16" O.C. (LUMBER SPECIES BY OTHERS)

(COVERED PORCH - FRONT) RAFTERS @ 16" O.C. (LUMBER SPECIES BY OTHERS)

(COVERED DECK - REAR) RAFTERS @ 16" O.C. (LUMBER SPECIES BY OTHERS)

NOTE:
UPGRADE TO STRONGER WOOD SPECIES IF
SPAN LENGTH EXCEEDS LOCAL CODE
-EXACT RAFTER, SIZE, GRADE, & SPACINGS TO
BE DETERMINED BY THE TOWN OR CITIES
GROUND SNOW LOAD.
-REFER TO TABLES R802.5.1(1)
-R802.5.1(8) IN THE 2015 IRC

2 x 8 CLG. JSTS. BETWEEN ALL RAFTERS

2 x 8 COLLAR TIES BETWEEN ALL RAFTERS

235# ASPHALT SHINGLES ON 15# ROOFING FELT ON 1/2" OR 5/8" EXT. GRADE PLYWOOD SHEATHING

ICE & WEATHER SHIELD AT RAFTER TAILS & VALLEYS

METAL DRIP EDGE 1x4 PINE BLOCKING (SUB-FASCIA) 1x8 PINE BD. FASCIA 3/8" AC EXT. GD. PLYWD SOFFIT W/2" CONT. LOUVERED VENT (SOFFIT ONLY)

(LENGTH TO EXCEED PLUM CUT OF RAFTER)

INTERIOR CONSTRUCTION: 2 x 4 WOOD STUDS @ 16" O.C. SINGLE TOP PLATE (DBL. ON LD. BRG.

WALLS ONLY) 2 x 4 SINGLE BOTTOM PLATE

1/2" GYPSUM WALL BOARD EA. SIDE STUD -MOISTURE-RESISTANT / FIRE-RATED WHERE REQUIRED

1/2" G.W.B. ON 1x3 WOOD STRAPPING @ 16"O.C.-MOISTURE-RESISTANT / FIRE-RATED WHERE REQUIRED

2x12 STAIR STRINGERS @ 12" O.C.

FOUNDATION CONSTRUCTION:

8"-10" CONCRETE FOUNDATION WALL WITH (2) 2x6 SILL PLATES (K.D. ON P.T.) WITH SILL SEAL ON TOP OF CONTINUOUS 1'-8" x 10" CONCRETE FOOTING

8"-10" CONC. FROST WALLS (WHERE SHOWN) TO BE 48" BELOW GRADE ON TOP OF CONTINUOUS 1'-8" x 10" CONCRETE FOOTING

PROVIDE 3 1/2" DIA. STEEL COLUMNS OVER SIZED CONC. FOOTINGS AS REQ D FOR BEAMS SHOWN ON PLAN REFER TO SECTION R404.1.3.2 FOR HORIZONTAL AND VERTICAL REINFORCEMENT FOR FOUNDATION WALLS PROVIDE MATCHING CORNER DOWELS LAP 50 BAR DIAMETERS (TYPICAL)

WOOD STUDS @ 16" O.C. W/TYVEK (OR EQUAL) WIND BARRIER AND 1/2" EXTERIOR GRADE PLYWOOD


2 x 6 DOUBLE TOP PLATE

2 x 6 SINGLE BOTTOM PLATE

CONTRACTOR TO PROVIDE ADEQUATE HEADERS OVER ALL WINDOWS AND DOORS ON EXTERIOR LOAD-BEARING WALLS (TYP.)

EXTERIOR WALL CONSTRUCTION:

BUILDING SECTION A/5

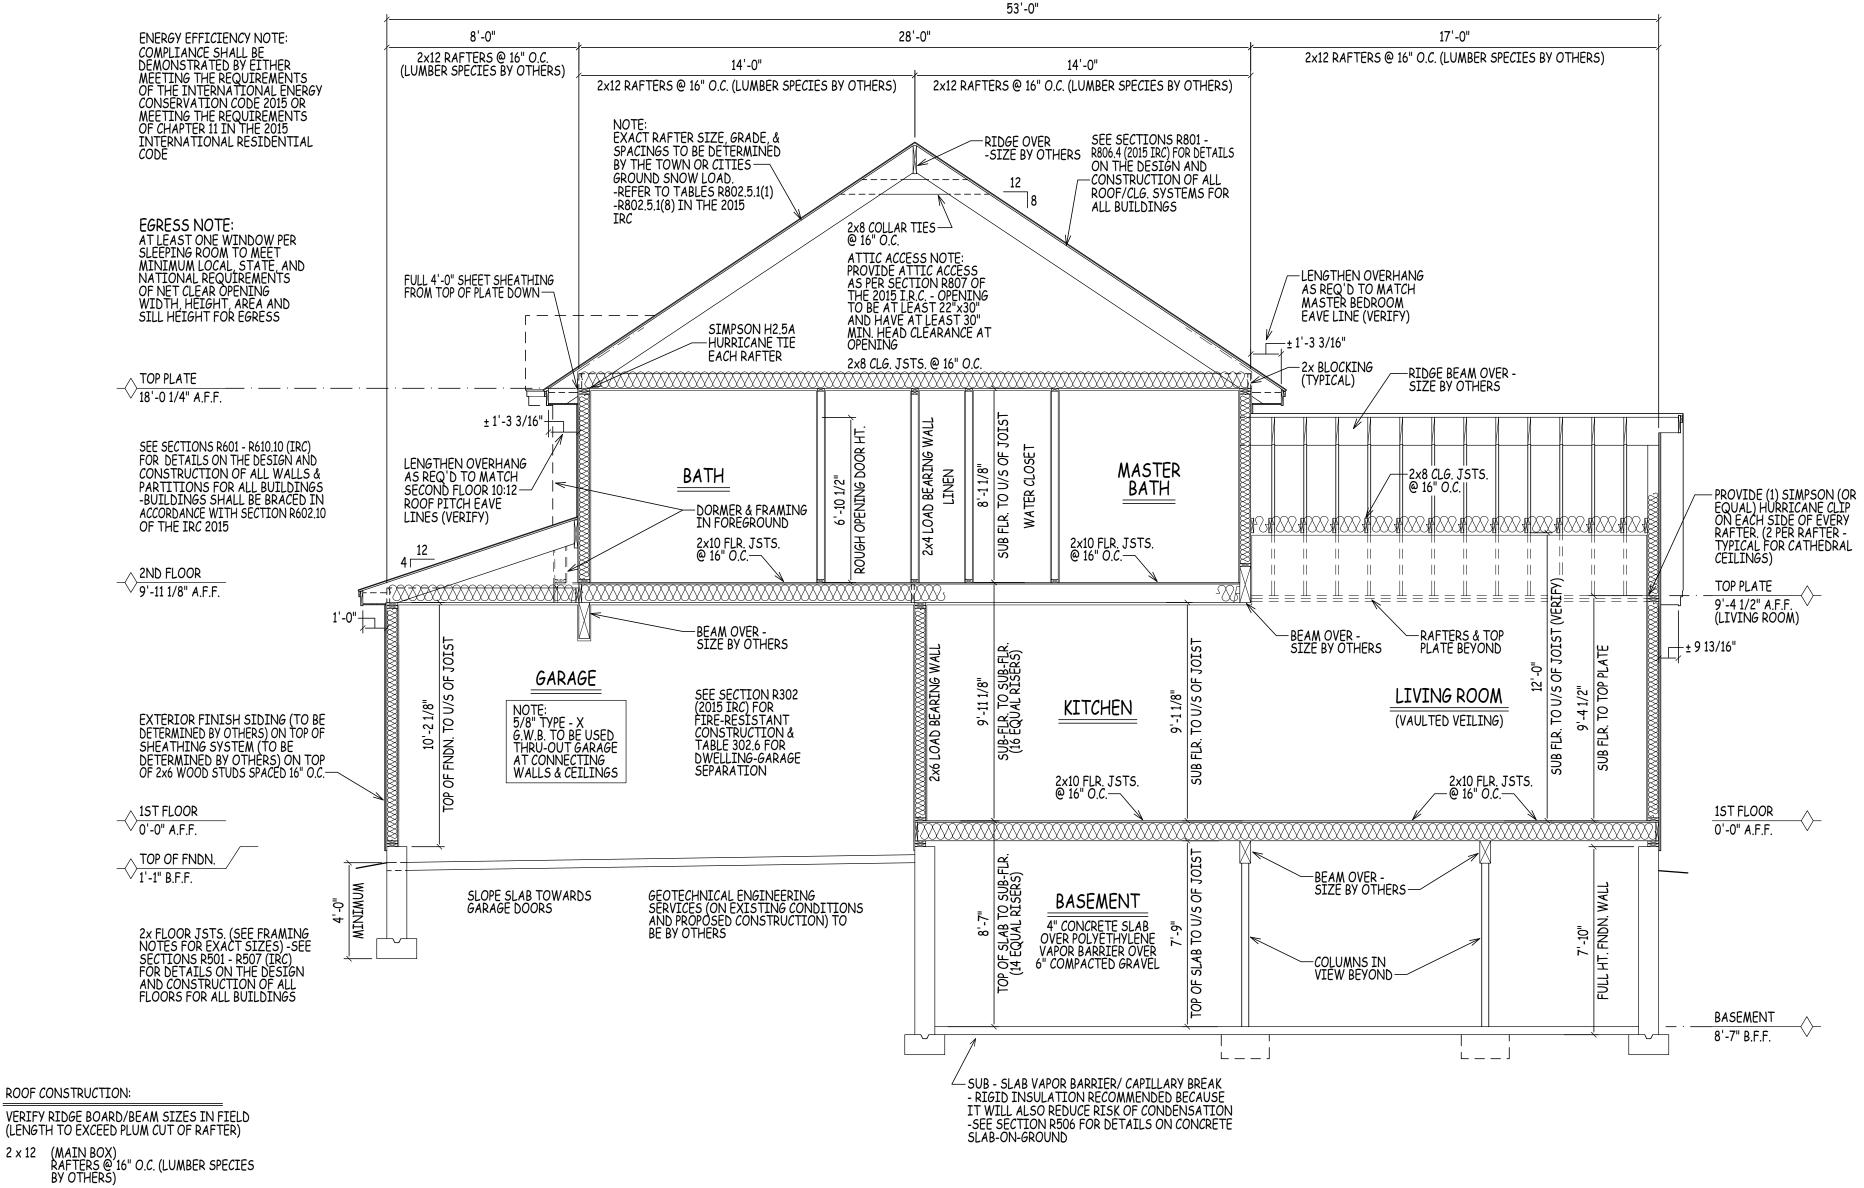

BUILDING SECTION C/6

SCALE: 1/4" = 1'-0"

INTERIOR CONSTRUCTION:

(COVERED PORCH - FRONT) RAFTERS @ 16" O.C. (LUMBER SPECIES BY OTHERS)

(COVERED DECK - REAR) RAFTERS @ 16" O.C. (LUMBER SPECIES BY OTHERS)

NUIL:
UPGRADE TO STRONGER WOOD SPECIES IF
SPAN LENGTH EXCEEDS LOCAL CODE
-EXACT RAFTER, SIZE, GRADE, & SPACINGS TO
BE DETERMINED BY THE TOWN OR CITIES
GROUND SNOW LOAD.
-REFER TO TABLES R802.5.1(1)
-R802.5.1(8) IN THE 2015 IRC

2 x 8 CLG. JSTS. BETWEEN ALL RAFTERS

2 x 8 COLLAR TIES BETWEEN ALL RAFTERS

235# ASPHALT SHINGLES ON 15# ROOFING FELT ON 1/2" OR 5/8" EXT. GRADE PLYWOOD SHEATHING

ICE & WEATHER SHIELD AT RAFTER TAILS & VALLEYS

METAL DRIP EDGE 1x4 PINE BLOCKING (SUB-FASCIA) 1x8 PINE BD. FASCIA 3/8" AC EXT. GD. PLYWD SOFFIT W/2" CONT. LOUVERED VENT (SOFFIT ONLY) 2 x 4 WOOD STUDS @ 16" O.C. 2 x 4 SINGLE TOP PLATE (DBL. ON LD. BRG.

WALLS ONLY)
2 x 4 SINGLE BOTTOM PLATE

WALL- 1/2" GYPSUM WALL BOARD EA. SIDE STUD -MOISTURE-RESISTANT / FIRE-RATED WHERE REQUIRED

CLG.- 1/2" G.W.B. ON 1x3 WOOD STRAPPING @ 16"O.C.-MOISTURE-RESISTANT / FIRE-RATED WHERE REQUIRED

2x12 STAIR STRINGERS @ 12" O.C.

FOUNDATION CONSTRUCTION:

8"-10" CONCRETE FOUNDATION WALL WITH (2) 2x6 SILL PLATES (K.D. ON P.T.) WITH SILL SEAL ON TOP OF CONTINUOUS 1'-8" x 10" CONCRETE FOOTING

8"-10" CONC. FROST WALLS (WHERE SHOWN) TO BE 48" BELOW GRADE ON TOP OF CONTINUOUS 1'-8" \times 10" CONCRETE FOOTING

PROVIDE 3 1/2" DIA. STEEL COLUMNS OVER SIZED CONC. FOOTINGS AS REQ D FOR BEAMS SHOWN ON PLAN REFER TO SECTION R404.1.3.2 FOR HORIZONTAL AND VERTICAL REINFORCEMENT FOR FOUNDATION WALLS

PROVIDE MATCHING CORNER DOWELS LAP 50 BAR DIAMETERS (TYPICAL)

EXTERIOR WALL CONSTRUCTION:

2 x 6 WOOD STUDS @ 16" O.C. W/TYVEK (OR EQUAL) WIND BARRIER AND 1/2" EXTERIOR GRADE PLYWOOD

2 x 6 DOUBLE TOP PLATE

2 x 6 SINGLE BOTTOM PLATE

CONTRACTOR TO PROVIDE ADEQUATE HEADERS OVER ALL WINDOWS AND DOORS ON EXTERIOR LOAD-BEARING WALLS (TYP.)

FLOOR CONSTRUCTION:

2x10 FLOOR JOISTS @ 16" O.C. W/ 3/4" TONGUE & GROOVE PLYWD. GLUED & NAILED (TYP. U.O.N.)

-SEE FLOOR PLANS FOR FRAMING DIRECTION/
SPACING NOTATION MARKERS

BUILT-UP BEAMS SIZED BY CONTRACTOR

DOUBLE UP FLOOR JOISTS @ LOCATIONS OF NON-LOAD BEARING WALLS AND UNDER ALL BATHING TUBS/WHIRLPOOLS & KITCHENS (TYP.)

INSULATION

VALLS: R-20 CAVITY INSULATION OR R-13 PLUS R-5 (ZONE 5) R-20 CAVITY INSULATION PLUS R-5 OR R-13 PLUS R-10 (ZONE 6)

VALUE OVER THE PLATES (RAISED) R-38 (ZONE 5 & 6)

FLOOR: R-30 OR INSULATION SUFFICIENT TO FILL JOIST CAVITY
CEILING: R-49 (ZONE 5 & 6) - HOWEVER, IF MAINTAINING THE FULL R

MOISTURE VAPOR RETARDERS SHALL BE INSTALLED IN ACCORDANCE WITH THE REQUIREMENTS SET FORTH IN THE 2015 I.R.C. SECTIONS R318.1, AND R702.7 MOISTURE CONTROL

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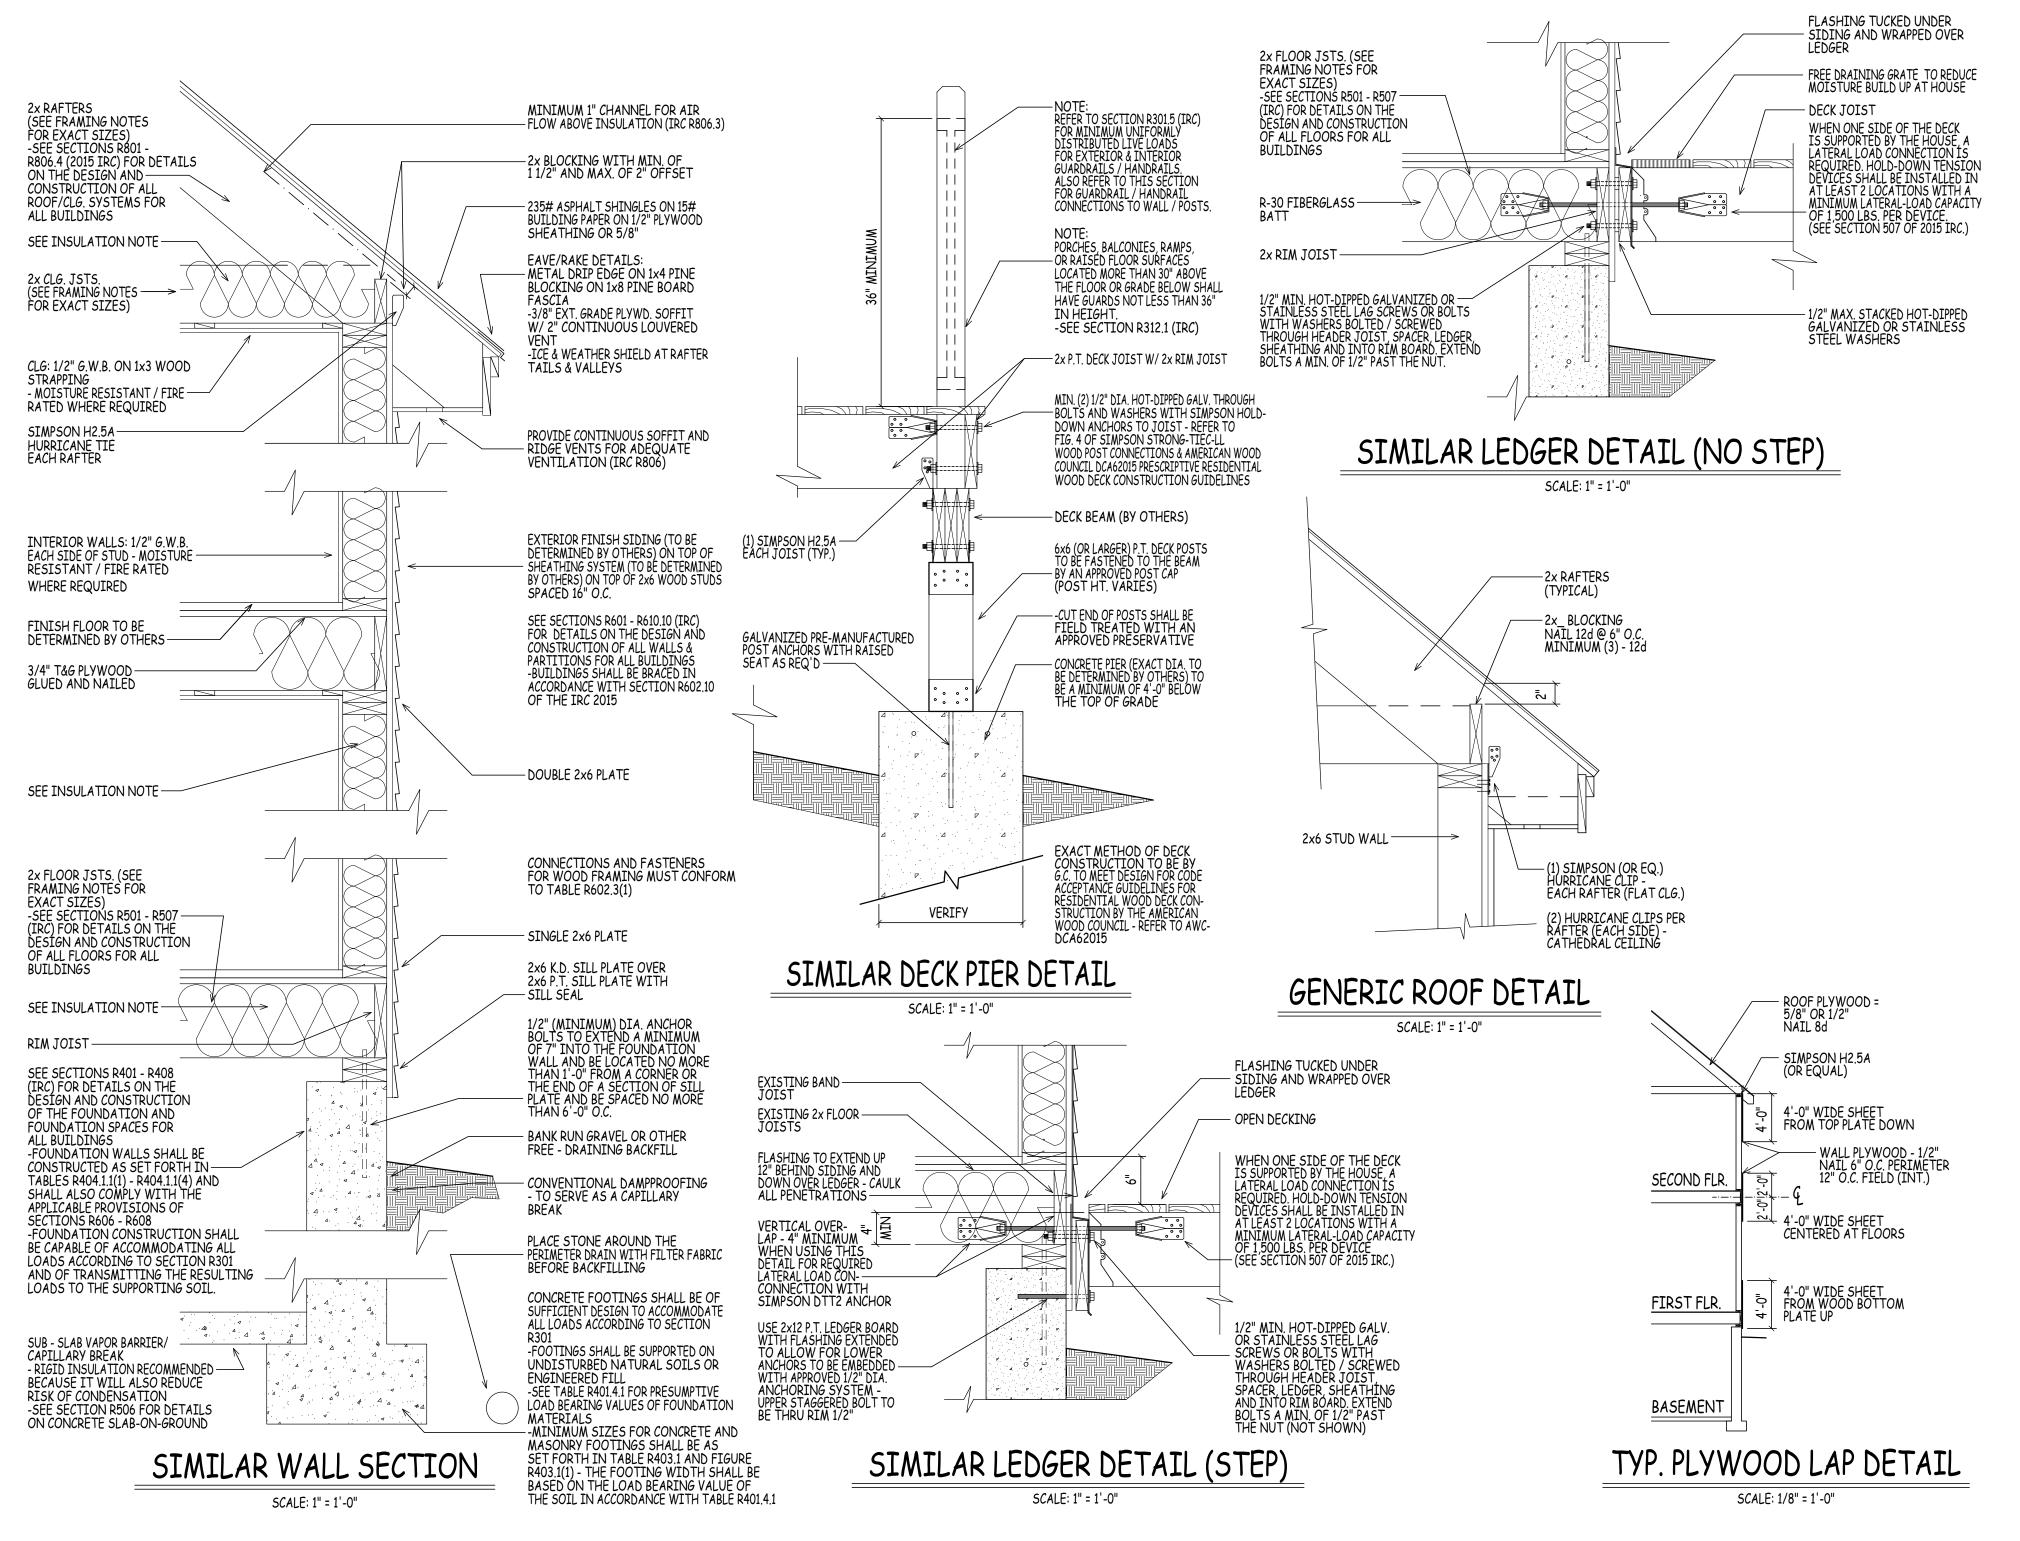
YOUNG ROAD LONDONDERRY NH - MODEL
PREPARED FOR:

DHB HOMES LLC.

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	DRAWN BY:	AD
	CHECKED BY: DATE DRAWN:	DHB
	DATE DRAWN:	12/07/21
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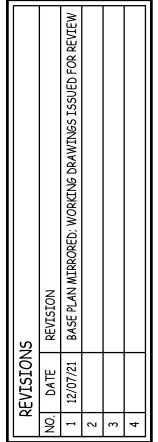



YOUNG ROAD LONDONDERRY NH - MODEL A

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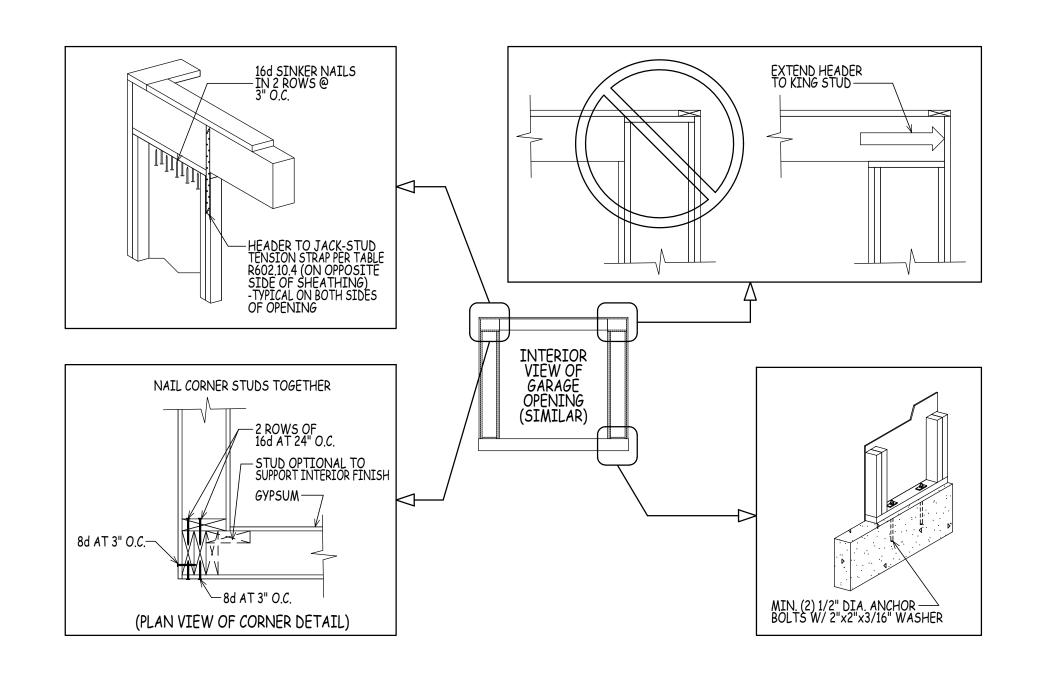
DHB HOMES LLC.


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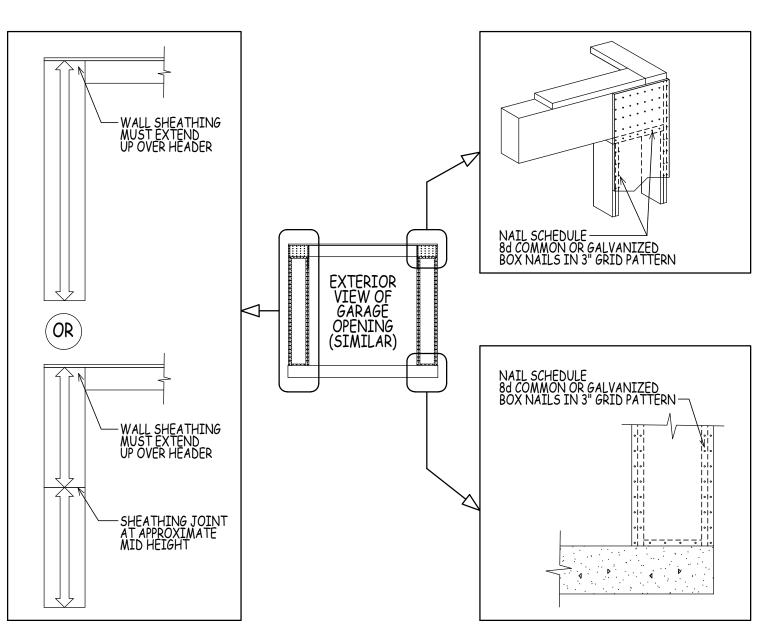
METHOD CS-PF (PORTAL FRAME CONSTRUCTION) SIMILAR TO FIGURE R602.10.6.4 2015 IRC



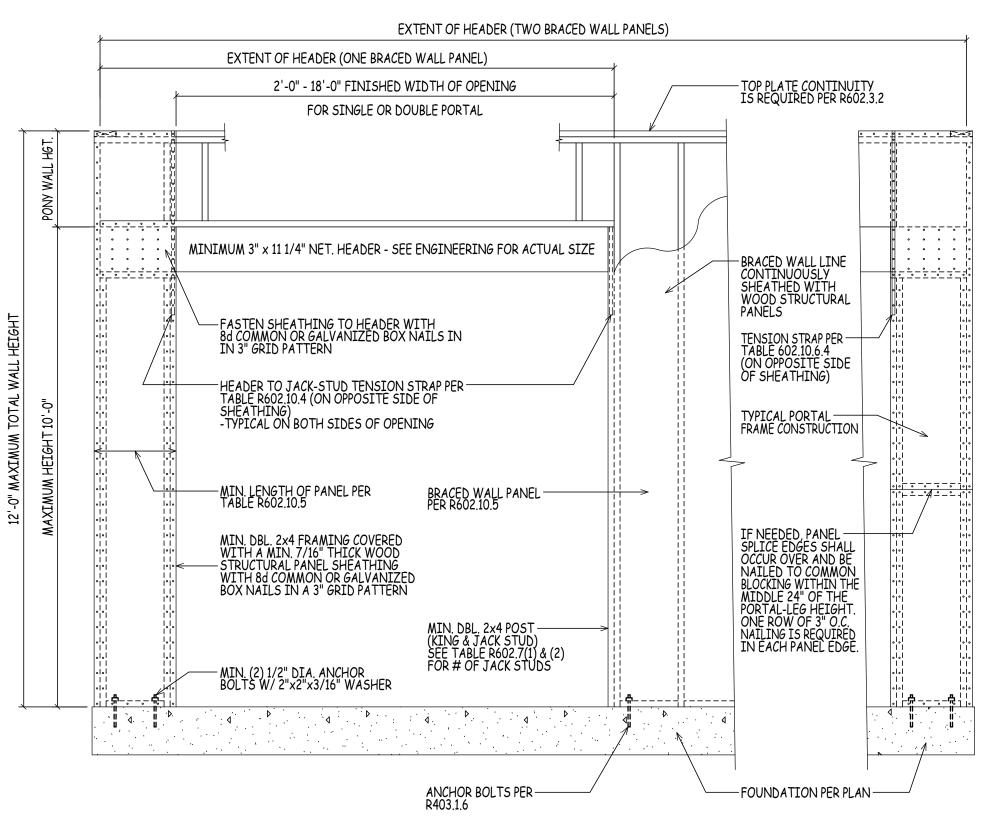

BUILDING SECTION D/8

SCALE: 1/4" = 1'-0"

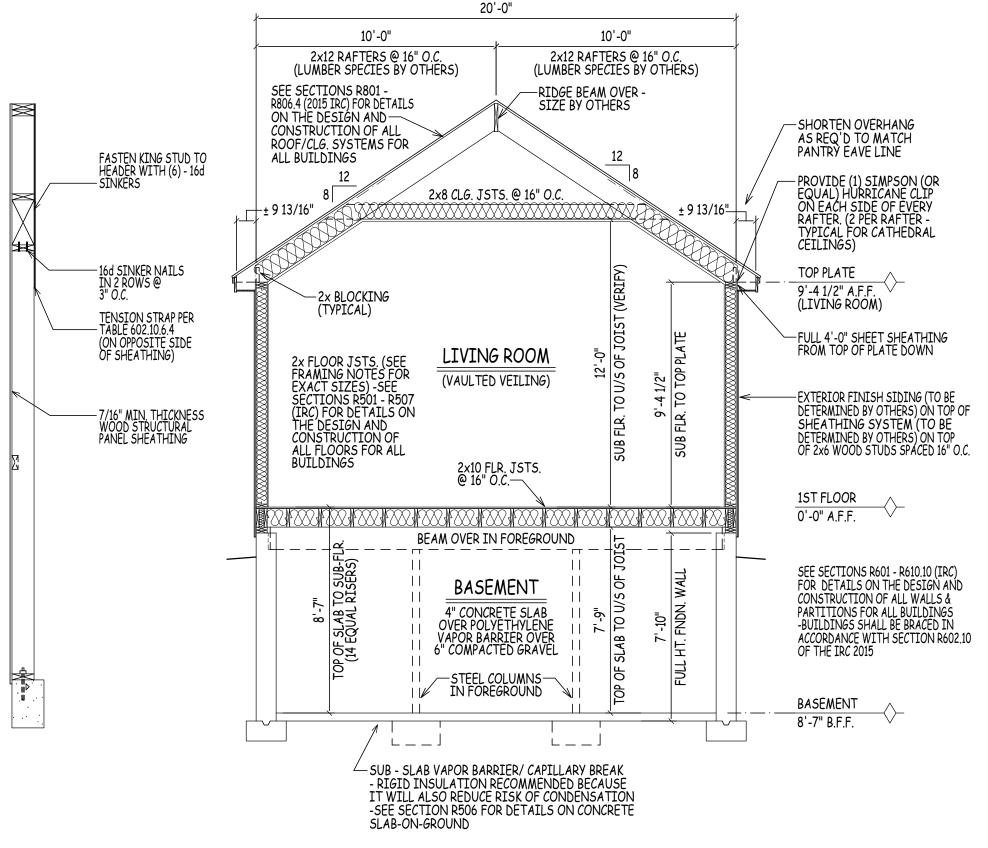



YOUNG ROAD LONDONDERRY NH - MODEL A
PREPARED FOR:
DHB HOMES LLC.

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