

NOTE:
SQUARE FOOTAGE INCLUDES AL
WALL STRUCTURE, LIVING SPACE
CLOSETS, STAIRS, & OPEN SPACE
HOWEVER, DOES NOT INCLUDE
GARAGE SPACE, DECKS, PATIOS,
OR OPEN AREAS.

TAKE NOTE THAT BUILDER'S SQ

TAKE NOTE THAT BUILDER'S SQUARE FOOTAGE CALCULATIONS MAY VARY FROM DRAFTER'S.

WINDOWS SHOWN IN PLAN VIEW ARE APPROX. ROUGH OPENING SIZE - NOT GLASS SIZE. SEE WINDOW SCHEDULE & VERIFY R.O. WITH WINDOW MANUFACTURER.

REFER TO SECTIONS R312.2.1 FOR WINDOW SILL HEIGHT ABOVE GROUND (OR SURFACE BELOW) AND TO SECTION 310 FOR EGRESS WINDOWS & BASEMENTS PRIOR TO PLACING WINDOW ORDER

REFER TO SECTION 311 FOR MEANS OF EGRESS PRIOR TO ORDERING DOORS WINDOWS TO HAVE OPENING LIMITING DEVICES AS PER R312 IRC 2015

WINDOWS TO COMPLY WITH SECTION R308 FOR TYPE OF GLASS AND SAFETY GLAZING STANDARD

1. DECK(S) NOT SHOWN FOR CLARITY CONSULT CONTRACTOR IN FIELD FO
EXACT SIZE & LOCATION

2. REFER TO FLOOR PLANS FOR EXACT
LOCATION OF WINDOWS & DOORS DO NOT SCALE FROM ELEVATIONS

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SOLAR-READY ZONE CERTIFICATE:
A PERMANENT CERTIFICATE INDICATING THIS RESIDENCE
IS A SOLAR-READY ZONE HOME AND ASSOCIATED
REQUIREMENTS SHALL BE POSTED PERMANENTLY NEAR THE
ELECTRICAL DISTRIBUTION PANEL THE GENERAL
CONTRACTOR PRIOR TO COMPLETION

C - HAVERHILL, MASSACHUSETTS

DHB HOMES LLC.

ADMISSION OF ERROR, OMISSION AND/OR OVERSIGHT:
WHILE IT IS OUR INTENT TO DELIVER OUR SERVICES FREE OF
ERROR, OMISSION OR OVERSIGHT, WE WILL ADMIT TO BE
HUMAN; AND THEREFORE FSM DRAWINGS LLC ACTING SOLEY
AS THE DRAFTING COMPANY WILL RELY ON THE EXPERIENCED
CONTRACTOR USING THESE PLANS TO THOROUGHLY REVIEW THEM
FOR DIMENSIONAL ACCURACY COMPLETENESS AND
APROPRIATENESS. THE CONTRACTOR USING THESE PLANS
ASSUMES ALL RESPONSIBILITY FOR THEM AND WILL IF HE/SHE
DEEMS NECESSARY HIRE A LICENSED PROFESSIONAL ENGINEER
TO ASSIST IN THE REVIEW.

DRAWN BY: JW
CHECKED BY: AO
DATE DRAWN: 05/30/24
DATE ISSUED: 05/30/24
SCALE: AS INDICATED

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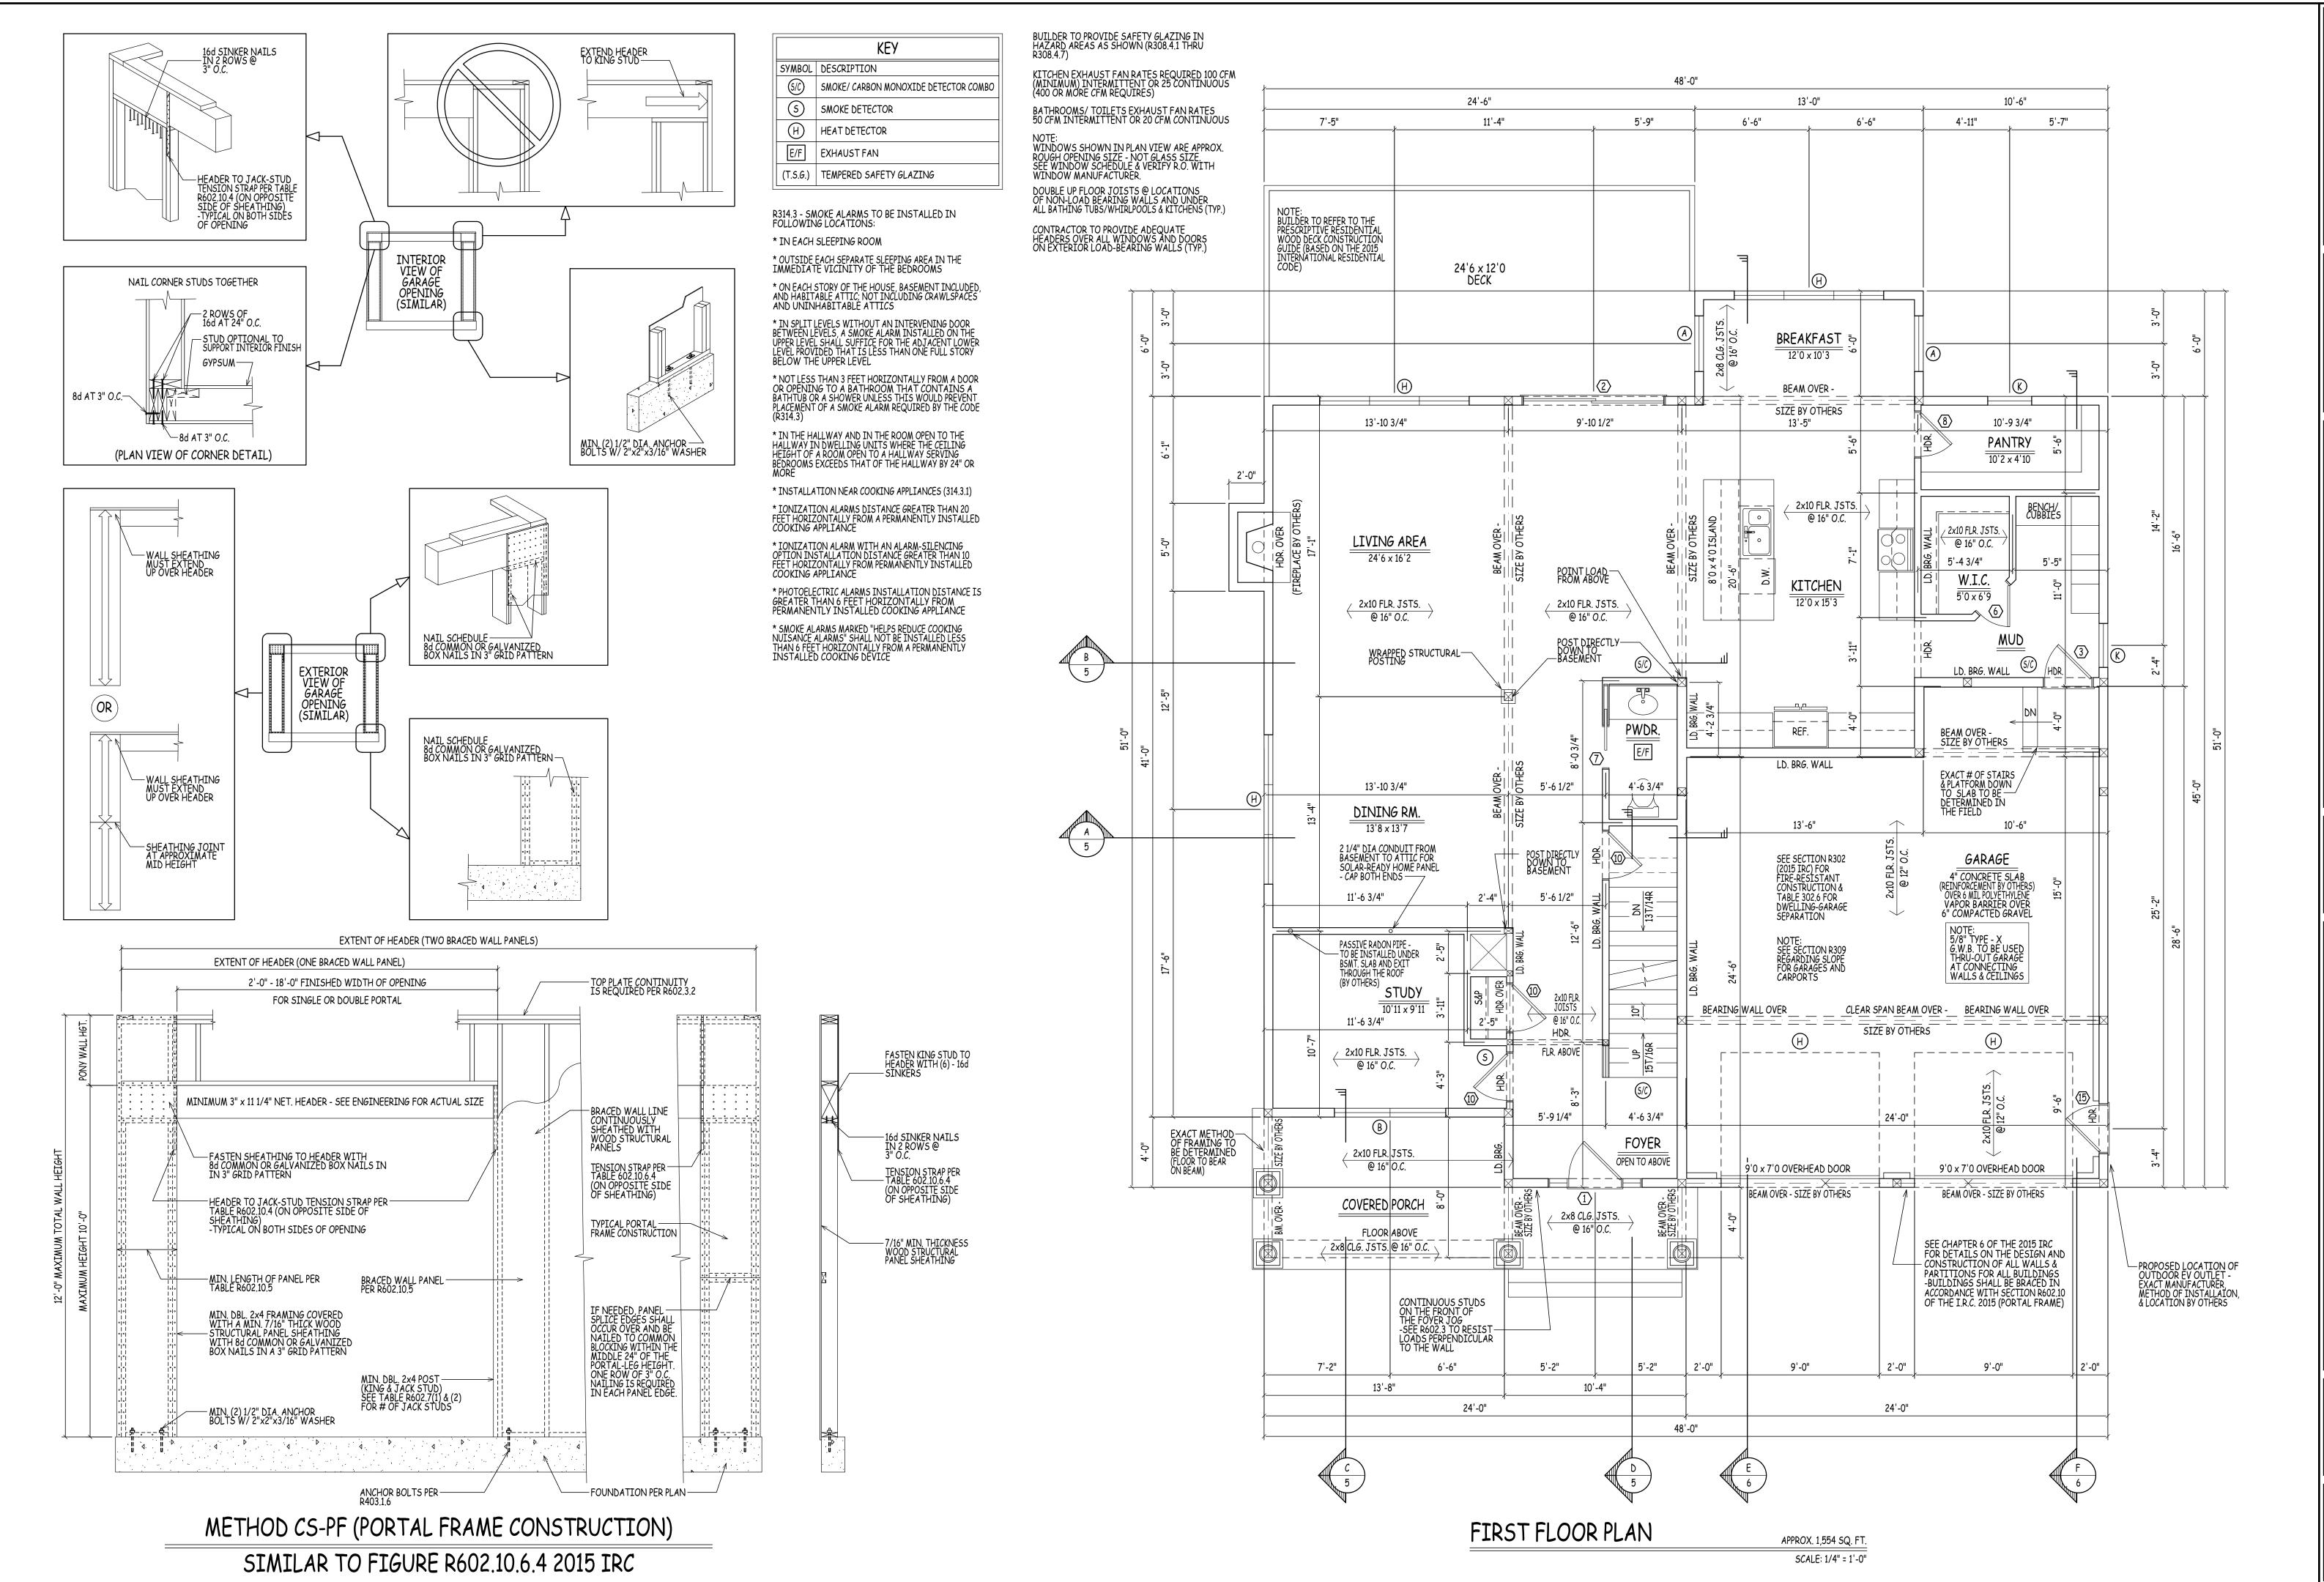
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ACHUSETTS

MODEL C - HAVERHILL, MASSA

REPARED FOR:

DHB HOMES LLC.

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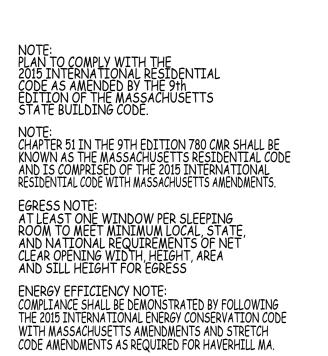
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15/30/24 REVISED WORKING DRAWINGS ISSUED FOR REVIEW

12/16/24 PLAN REVISED; WORKING DRAWINGS ISSUED FOR REVIEW

15/28/24 PLAN REVISED; PROGRESS PLAN ISSUED FOR REVIEW




THE 2015 INTERNATIONAL ENERGY CONSERVATION COLUMN MASSACHUSETTS AMENDMENTS AND STRETCH CODE AMENDMENTS AS REQUIRED FOR HAVERHILL MA.

NOTE:
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ROUGH OPENING SIZE - NOT GLASS SIZE.
SEE WINDOW SCHEDULE & VERIFY R.O. WITH WINDOW MANUFACTURER.

THE CONTRACTOR IS TO ENSURE WINDOWS MEET PREVAILING BUILDING AND LIFESAFETY CODES FOR MINIMUM EGRESS CLEAR OPENING HEIGHT, WIDTH, AND AREA - THE CONTRACTOR WILL ADJUST WINDOW SCHEDULE ACCORDINGLY.

REFER TO SECTIONS R312.2.1 FOR WINDOW SILL HEIGHT ABOVE GROUND (OR SURFACE BELOW) AND TO SECTION 310 FOR EGRESS WINDOWS & BASEMENTS PRIOR TO PLACING WINDOW ORDER REFER TO SECTION 311 FOR MEANS OF EGRESS PRIOR TO ORDERING DOORS

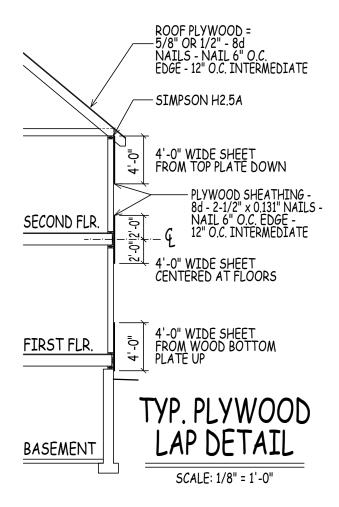

KEY					
SYMBOL	DESCRIPTION				
(S/C)	SMOKE/ CARBON MONOXIDE DETECTOR COMBO				
(5)	SMOKE DETECTOR				
H	HEAT DETECTOR				
E/F	EXHAUST FAN				
(T.S.G.)	TEMPERED SAFETY GLAZING				

R314.3 - SMOKE ALARMS TO BE INSTALLED IN FOLLOWING LOCATIONS:

\* IN EACH SLEEPING ROOM

\* OUTSIDE EACH SEPARATE SLEEPING AREA IN THE IMMEDIATE VICINITY OF THE BEDROOMS

\* ON EACH STORY OF THE HOUSE, BASEMENT INCLUDED, AND HABITABLE ATTIC; NOT INCLUDING CRAWLSPACES AND UNINHABITABLE ATTICS

\* IN SPLIT LEVELS WITHOUT AN INTERVENING DOOR BETWEEN LEVELS, A SMOKE ALARM INSTALLED ON THE UPPER LEVEL SHALL SUFFICE FOR THE ADJACENT LOWER LEVEL PROVIDED THAT IS LESS THAN ONE FULL STORY BELOW THE UPPER LEVEL

\* NOT LESS THAN 3 FEET HORIZONTALLY FROM A DOOR OR OPENING TO A BATHROOM THAT CONTAINS A BATHTUB OR A SHOWER UNLESS THIS WOULD PREVENT PLACEMENT OF A SMOKE ALARM REQUIRED BY THE CODE (R314.3)

\* IN THE HALLWAY AND IN THE ROOM OPEN TO THE HALLWAY IN DWELLING UNITS WHERE THE CEILING HEIGHT OF A ROOM OPEN TO A HALLWAY SERVING BEDROOMS EXCEEDS THAT OF THE HALLWAY BY 24" OR MORE

\* INSTALLATION NEAR COOKING APPLIANCES (314.3.1)

\* IONIZATION ALARMS DISTANCE GREATER THAN 20 FEET HORIZONTALLY FROM A PERMANENTLY INSTALLED COOKING APPLIANCE

\* IONIZATION ALARM WITH AN ALARM-SILENCING OPTION INSTALLATION DISTANCE GREATER THAN 10 FEET HORIZONTALLY FROM PERMANENTLY INSTALLED COOKING APPLIANCE

\* PHOTOELECTRIC ALARMS INSTALLATION DISTANCE IS GREATER THAN 6 FEET HORIZONTALLY FROM PERMANENTLY INSTALLED COOKING APPLIANCE

\* SMOKE ALARMS MARKED "HELPS REDUCE COOKING NUISANCE ALARMS" SHALL NOT BE INSTALLED LESS THAN 6 FEET HORIZONTALLY FROM A PERMANENTLY INSTALLED COOKING DEVICE


	WINDOW SCHEDULE							
MARK	QTY	ROUGH OPENING	RSO	NOTES				
Α		38" x 61 1/2"		DBL. HUNG (EGRESS)				
В		76" x 61 1/2"		2 WIDE DBL. HUNG (EGRESS)				
С		38" x 45 1/2" (VERIFY)		DBL. HUNG				
D		76" x 45 1/2" (VERIFY)		2 WIDE DBL. HUNG				
Е		30" x 41 1/2"		DBL. HUNG				
F		60" x 41 1/2"		2 WIDE DBL. HUNG (T.S.G.)				
G		68" x 61 1/2"		2 WIDE DBL. HUNG				
Н		102" x 61 1/2"		3 WIDE DBL. HUNG				
J		114" x 61 1/2"		3 WIDE DBL. HUNG				
K		30" x 61 1/2"		DBL. HUNG				
L		30" x 41 1/2"		DBL. HUNG (T.S.G.)				
М		68" x 41 1/2"		2 WIDE DBL. HUNG				


CONTRACTOR TO DETERMINE FINAL WINDOW COUNT
WINDOWS TO HAVE GUARDS AND WINDOW FALL PROTECTION AS PER R312 IRC 2015
WINDOWS TO COMPLY WITH SECTION R308 FOR TYPE OF
GLASS AND SAFETY GLAZING STANDARD

(NOTE: HARVEY WINDOW SIZES ARE GIVEN
ABOVE ONLY FOR THE PURPOSE OF PROVIDING A REFERENCE
FOR COMPARING ROUGH OPENING SIZES WITH ANOTHER
MANUFACTURER. CONSULT CONTRACTOR FOR THE EXACT RO
& WINDOW MANUFACTURER CHOSEN FOR THIS HOME)

	DOOR SCHEDULE							
MARK	QTY	SIZE	R5O	NOTES				
1		(VERIFY)		ENTRY DOOR W/ SIDELITES				
2		96 1/4" x 80 1/4"		EXT. GLASS SLIDER				
3		34 1/2" x 82 1/2"		FIRE RATED DOOR				
4		22 1/2" x 82 1/2"		INTERIOR				
5		26 1/2" x 82 1/2"		INTERIOR				
6		30 1/2" x 82 1/2"		INTERIOR				
7		(VERIFY R.O.)		INTERIOR POCKET DOOR				
8		32 1/2" x 82 1/2"		INTERIOR				
9		(VERIFY R.O.)		INTERIOR POCKET DOOR				
10		34 1/2" x 82 1/2"		INTERIOR				
11		50 1/2" x 82 1/2"		INTERIOR DOUBLE DOORS				
12		62 1/2" x 82 1/2"		INTERIOR DOUBLE DOORS				
13		74 1/2" x 82 1/2"		INTERIOR DOUBLE DOORS				
14		(VERIFY)		SHOWER DOOR				
15		34 1/2" x 82 1/2"		EXT. 9-LITE DOOR				


## RSO TO BE DETERMINED BY DOOR MANUFACTURER CONTRACTOR TO DETERMINE FINAL DOOR COUNT

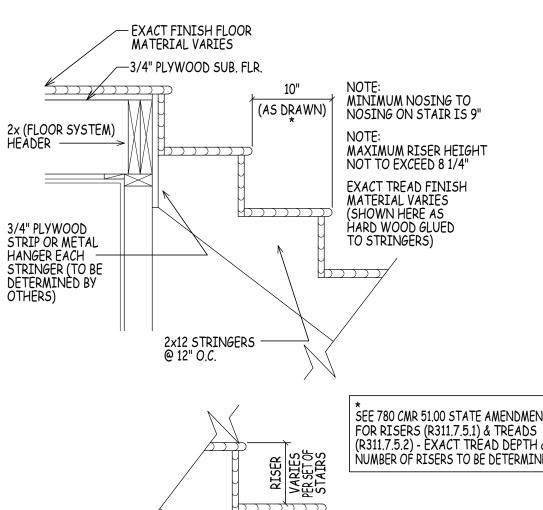

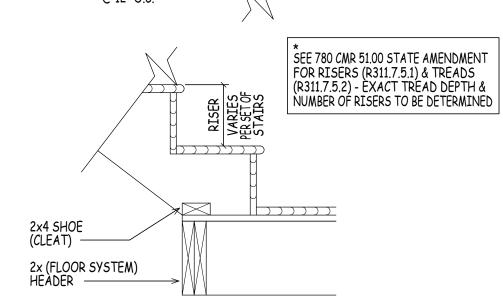

SCALE: 1" = 1'-0"

## GENERIC STAIR DETAILS

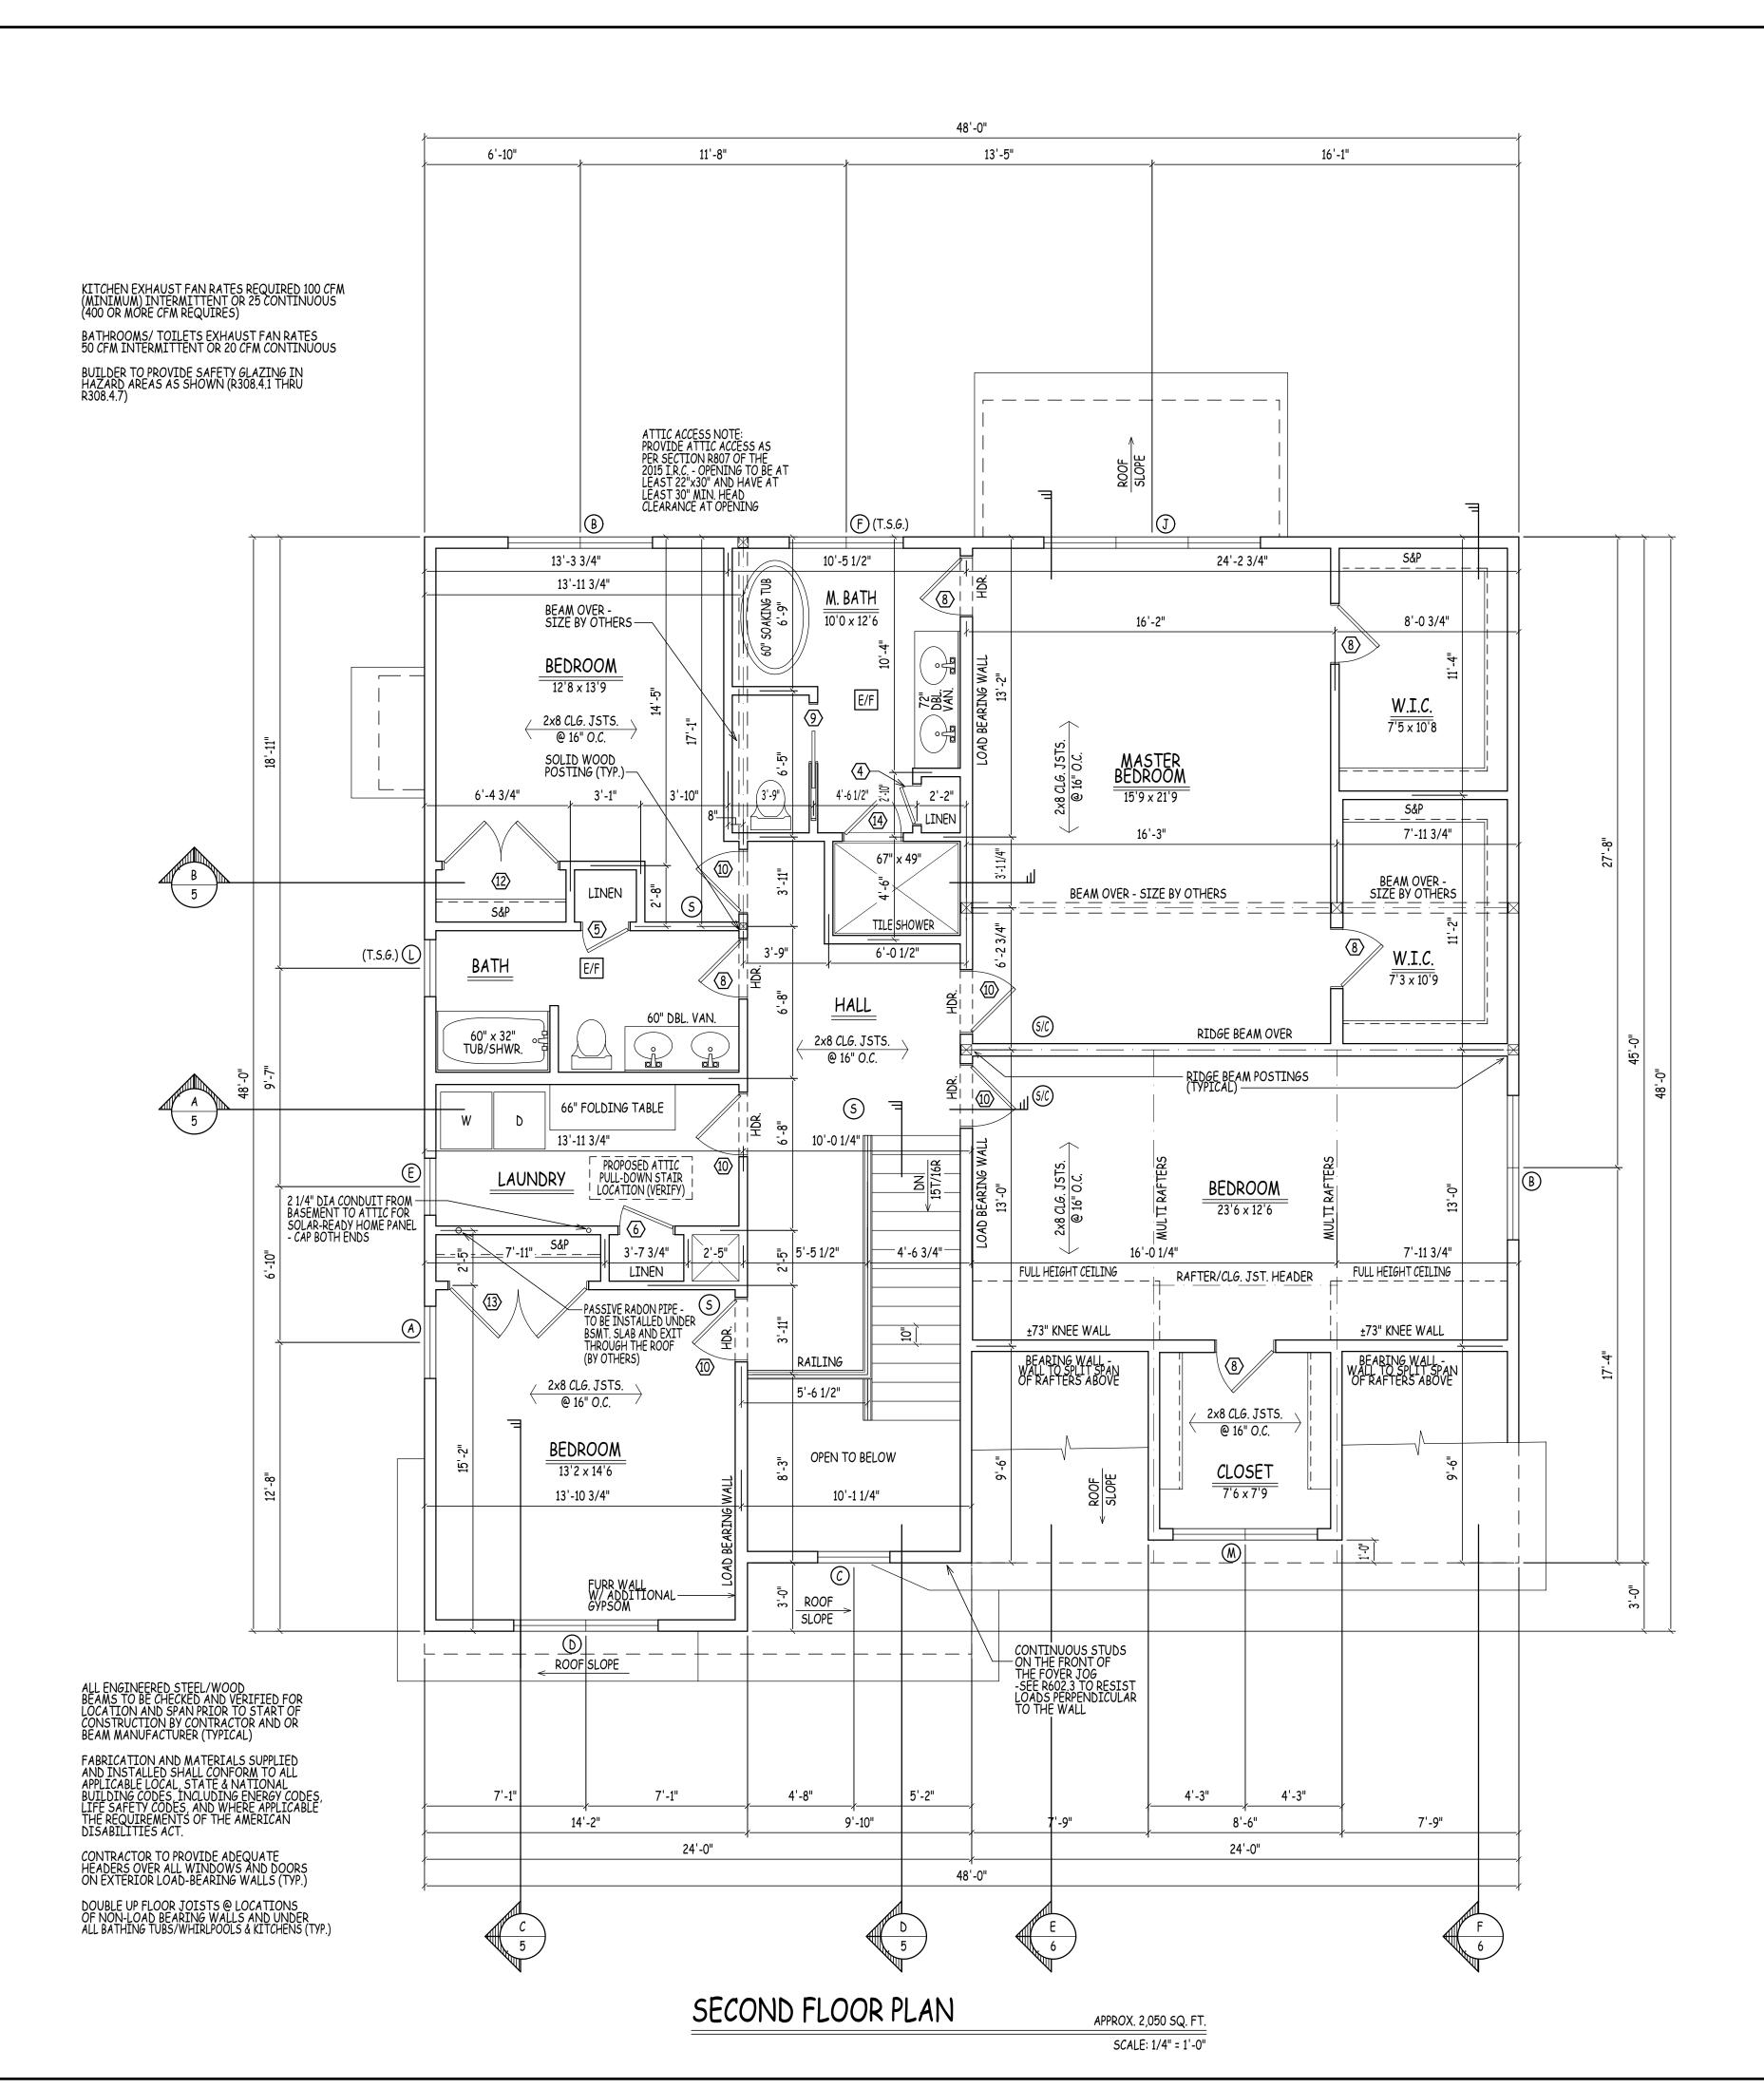

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D R A W I N G S

C) 2024 FSM DRAWINGS LLC

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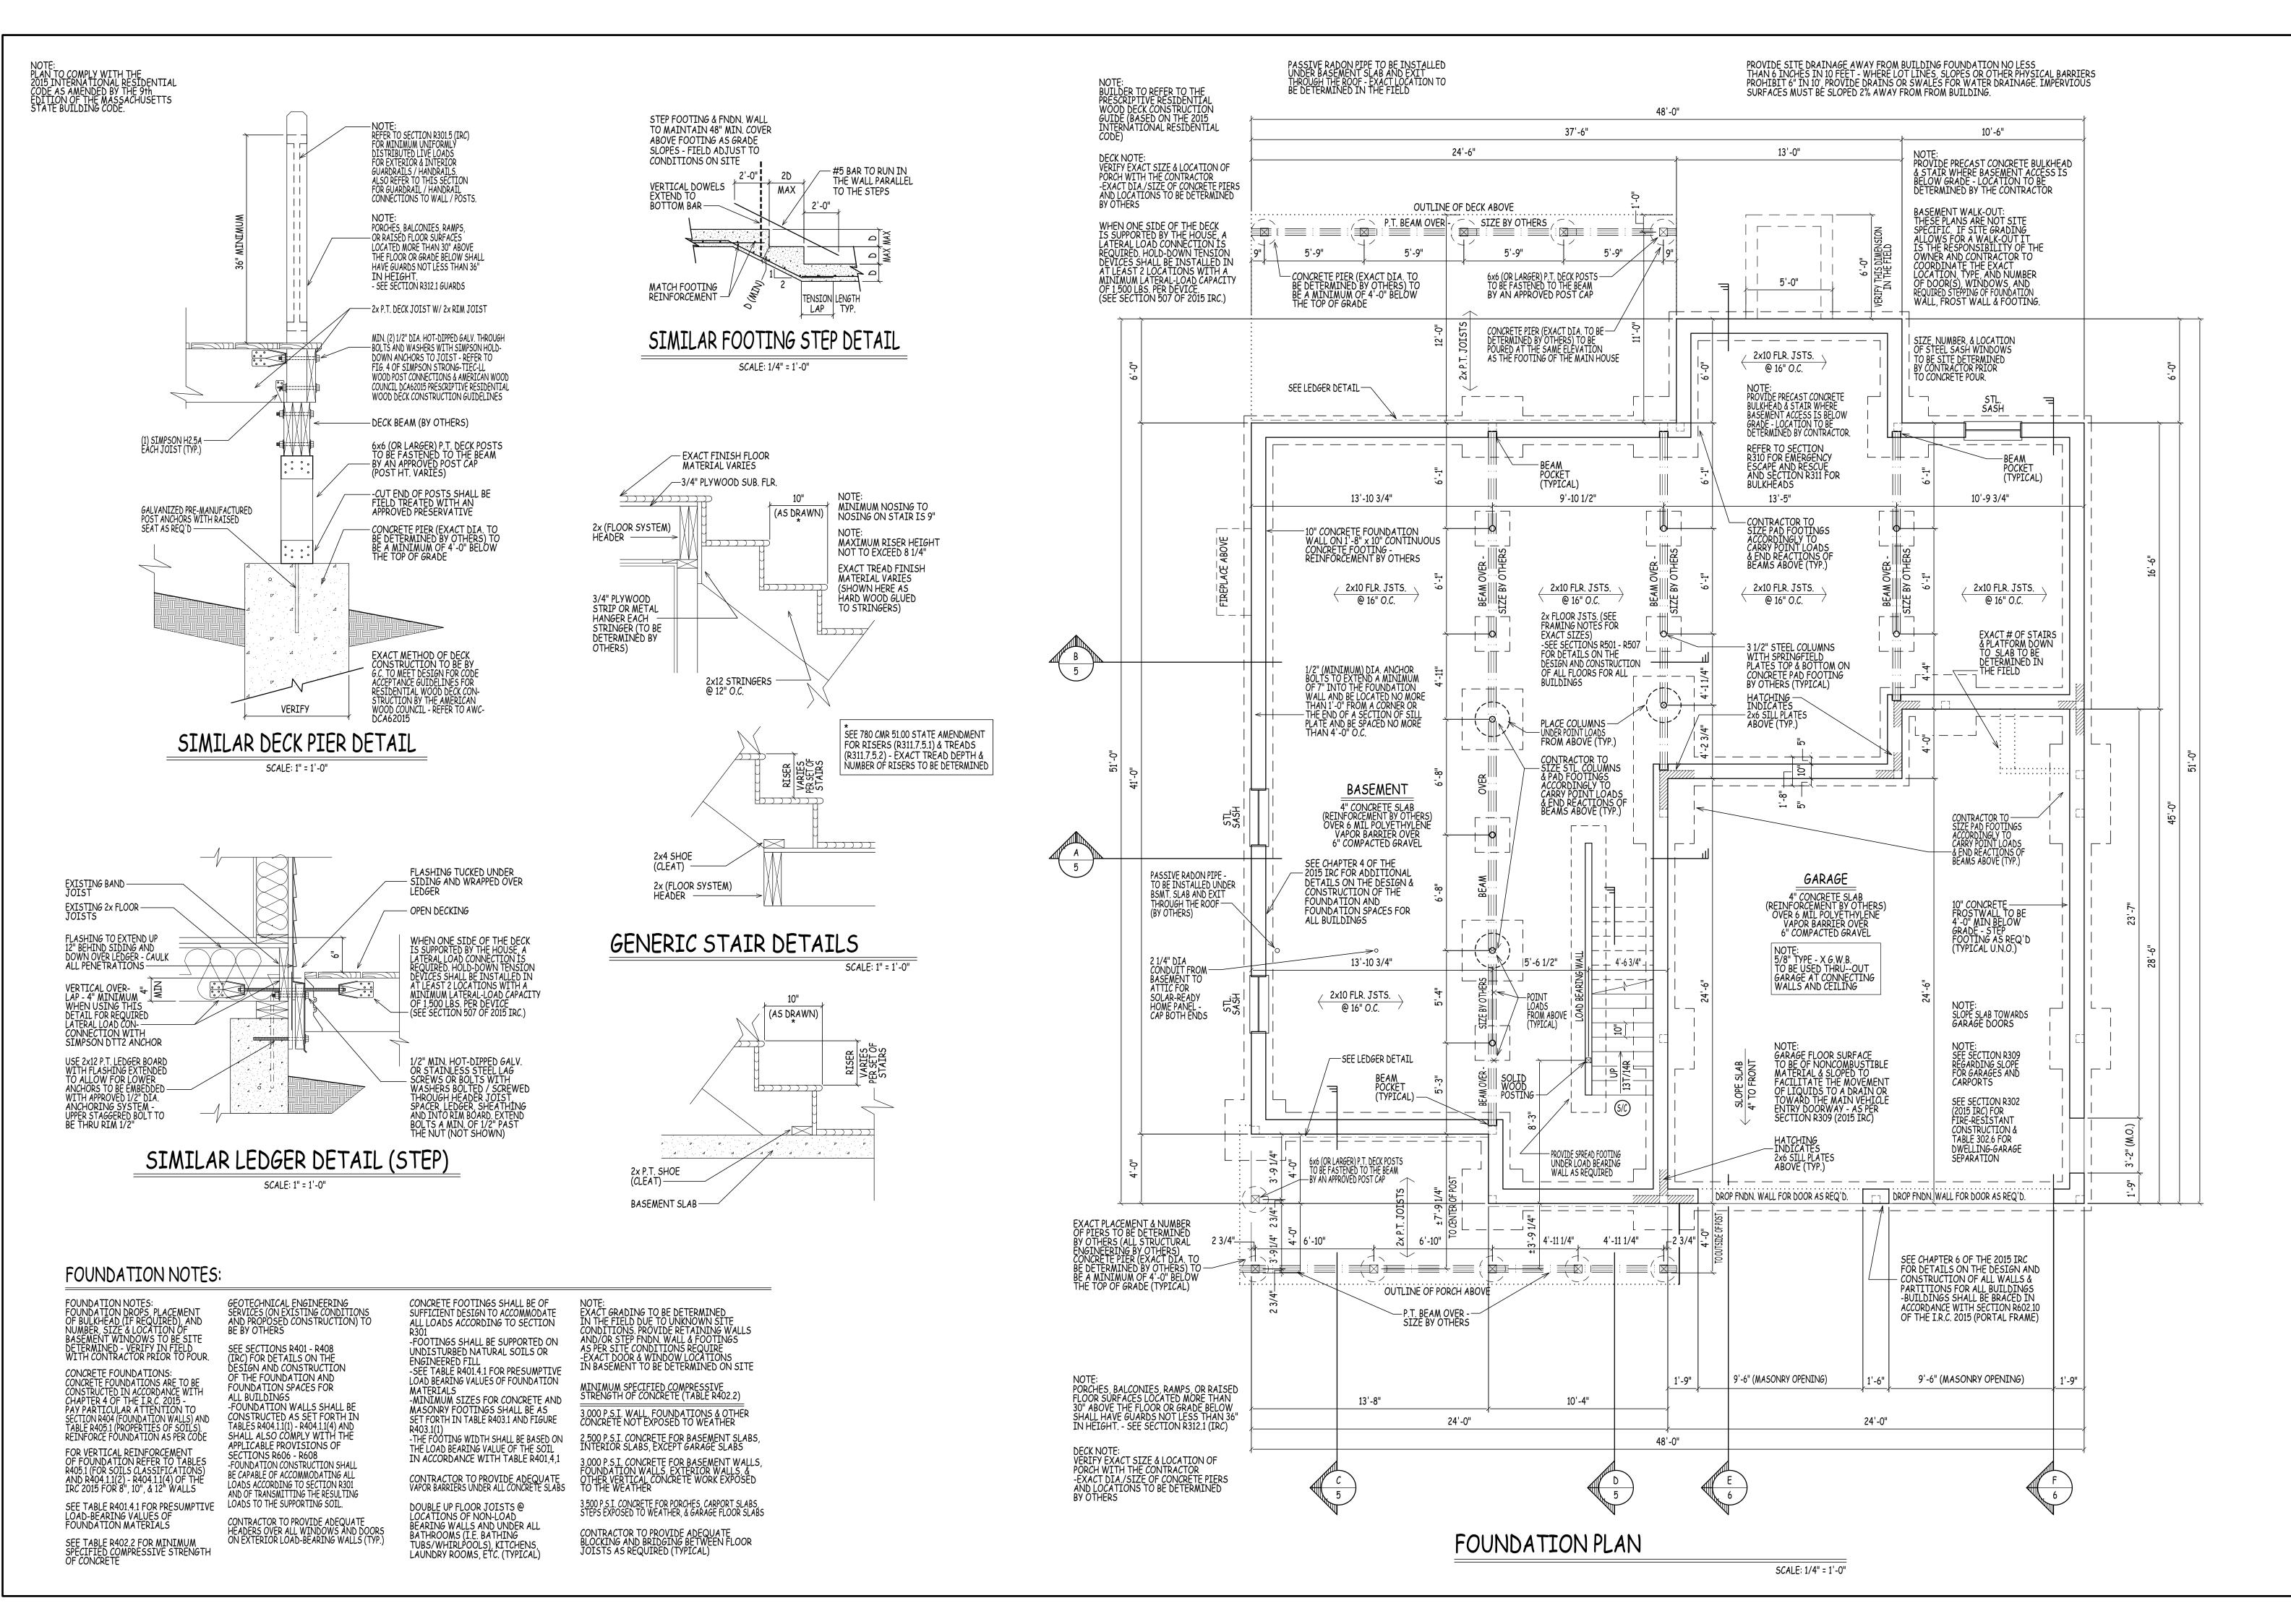
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DRAWINGS LLC

AVERHILL, MASSACHUSETT DHB HOMES LLC.

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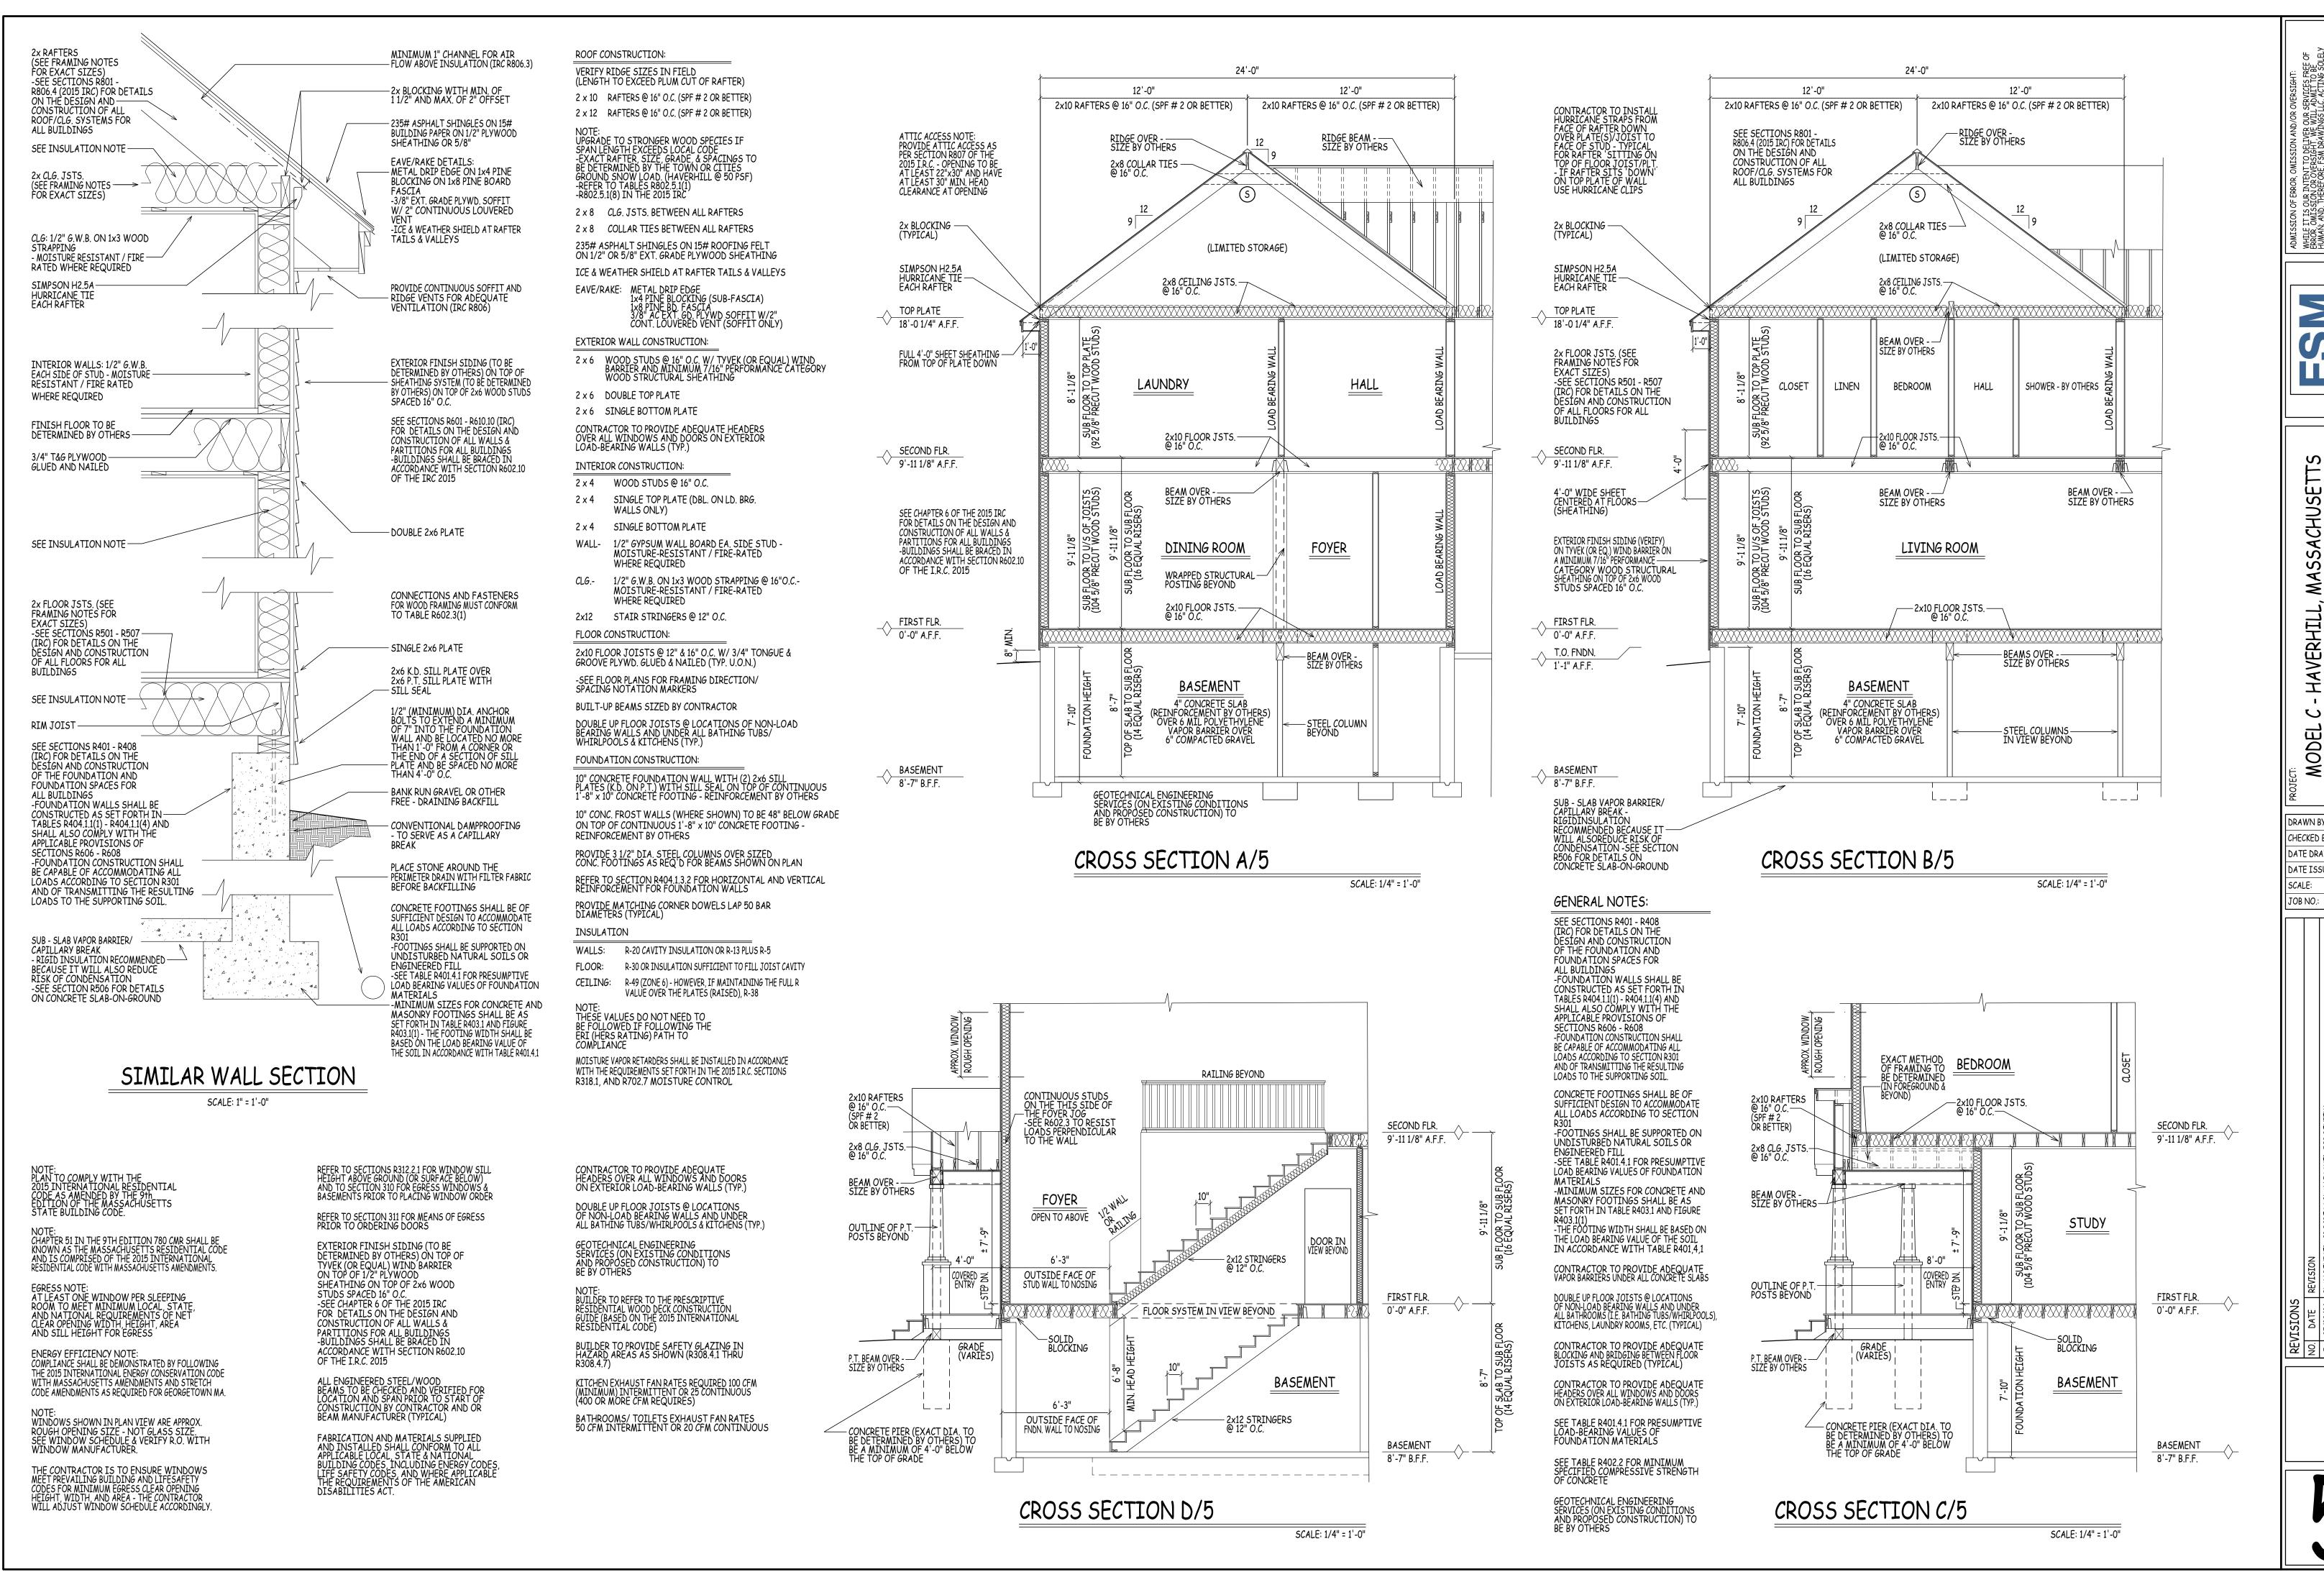
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WHILE IT ERROR, OA HUMAN, AA AANAMA, A CON TRAC, A FOR DIME APPROPRI, ASSUMES

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CHAPTER 51 IN THE 9TH EDITION 780 CMR SHALL BE KNOWN AS THE MASSACHUSETTS RESIDENTIAL CODE AND IS COMPRISED OF THE 2015 INTERNATIONAL RESIDENTIAL CODE WITH MASSACHUSETTS AMENDMENTS. AT LEAST ONE WINDOW PER SLEEPING ROOM TO MEET MINIMUM LOCAL, STATE, AND NATIONAL REQUIREMENTS OF NET CLEAR OPENING WIDTH, HEIGHT, AREA AND SILL HEIGHT FOR EGRESS ENERGY EFFICIENCY NOTE: COMPLIANCE SHALL BE DEMONSTRATED BY FOLLOWING THE 2015 INTERNATIONAL ENERGY CONSERVATION CODE WITH MASSACHUSETTS AMENDMENTS AND STRETCH CODE AMENDMENTS AS REQUIRED FOR GEORGETOWN MA. WINDOWS SHOWN IN PLAN VIEW ARE APPROX. ROUGH OPENING SIZE - NOT GLASS SIZE. SEE WINDOW SCHEDULE & VERIFY R.O. WITH WINDOW MANUFACTURER. THE CONTRACTOR IS TO ENSURE WINDOWS MEET PREVAILING BUILDING AND LIFESAFETY CODES FOR MINIMUM EGRESS CLEAR OPENING HEIGHT, WIDTH, AND AREA - THE CONTRACTOR WILL ADJUST WINDOW SCHEDULE ACCORDINGLY.

REFER TO SECTIONS R312.2.1 FOR WINDOW SILL HEIGHT ABOVE GROUND (OR SURFACE BELOW) AND TO SECTION 310 FOR EGRESS WINDOWS & BASEMENTS PRIOR TO PLACING WINDOW ORDER REFER TO SECTION 311 FOR MEANS OF EGRESS PRIOR TO ORDERING DOORS EXTERIOR FINISH SIDING (TO BE DETERMINED BY OTHERS) ON TOP OF TYVEK (OR EQUAL) WIND BARRIER ON TOP OF 1/2" PLYWOOD SHEATHING ON TOP OF 2x6 WOOD STUDE COMES TO SEE A STUDIE OF 1/2 OF 1/ STUDS SPACED 16" O.C.
-SEE CHAPTER 6 OF THE 2015 IRC
FOR DETAILS ON THE DESIGN AND CONSTRUCTION OF ALL WALLS & PARTITIONS FOR ALL BUILDINGS -BUILDINGS SHALL BE BRACED IN ACCORDANCE WITH SECTION R602.10 OF THE I.R.C. 2015 ALL ENGINEERED STEEL/WOOD BEAMS TO BE CHECKED AND VERIFIED FOR LOCATION AND SPAN PRIOR TO START OF CONSTRUCTION BY CONTRACTOR AND OR BEAM MANUFACTURER (TYPICAL) FABRICATION AND MATERIALS SUPPLIED AND INSTALLED SHALL CONFORM TO ALL APPLICABLE LOCAL, STATE & NATIONAL BUILDING CODES, INCLUDING ENERGY CODES, LIFE SAFETY CODES, AND WHERE APPLICABLE THE REQUIREMENTS OF THE AMERICAN DISABILITIES ACT.

CONTRACTOR TO PROVIDE ADEQUATE HEADERS OVER ALL WINDOWS AND DOORS ON EXTERIOR LOAD-BEARING WALLS (TYP.) DOUBLE UP FLOOR JOISTS @ LOCATIONS OF NON-LOAD BEARING WALLS AND UNDER ALL BATHING TUBS/WHIRLPOOLS & KITCHENS (TYP.) NOTE:
DUILDER TO REFER TO THE PRESCRIPTIVE
RESIDENTIAL WOOD DECK CONSTRUCTION
RUIDE (BASED ON THE 2015 INTERNATIONAL
RESIDENTIAL CODE) BUILDER TO PROVIDE SAFETY GLAZING IN HAZARD AREAS AS SHOWN (R308.4.1 THRU R308.4.7) KITCHEN EXHAUST FAN RATES REQUIRED 100 CFM (MINIMUM) INTERMITTENT OR 25 CONTINUOUS (400 OR MORE CFM REQUIRES)

BATHROOMS/ TOILETS EXHAUST FAN RATES 50 CFM INTERMITTENT OR 20 CFM CONTINUOUS

GENERAL NOTES: SEE SECTIONS R401 - R408 (IRC) FOR DETAILS ON THE DESIGN AND CONSTRUCTION OF THE FOUNDATION AND FOUNDATION SPACES FOR ALL BUILDINGS
-FOUNDATION WALLS SHALL BE
CONSTRUCTED AS SET FORTH IN
TABLES R404.1.1(1) - R404.1.1(4) AND
SHALL ALSO COMPLY WITH THE
APPLICABLE PROVISIONS OF SECTIONS R606 - R608 -FOUNDATION CONSTRUCTION SHALL BE CAPABLE OF ACCOMMODATING ALL LOADS ACCORDING TO SECTION R301 AND OF TRANSMITTING THE RESULTING LOADS TO THE SUPPORTING SOIL. CONCRETE FOOTINGS SHALL BE OF SUFFICIENT DESIGN TO ACCOMMODATE ALL LOADS ACCORDING TO SECTION -FOOTINGS SHALL BE SUPPORTED ON UNDISTURBED NATURAL SOILS OR ENGINEERED FILL -SEE TABLE R401.4.1 FOR PRESUMPTIVE LOAD BEARING VALUES OF FOUNDATION MATERIALS -MINIMUM SIZES FOR CONCRETE AND MASONRY FOOTINGS SHALL BE AS SET FORTH IN TABLE R403.1 AND FIGURE R403.1(1)
-THE FOOTING WIDTH SHALL BE BASED ON THE LOAD BEARING VALUE OF THE SOIL IN ACCORDANCE WITH TABLE R401,4,1

CONTRACTOR TO PROVIDE ADEQUATE VAPOR BARRIERS UNDER ALL CONCRETE SLABS DOUBLE UP FLOOR JOISTS @ LOCATIONS OF NON-LOAD BEARING WALLS AND UNDER ALL BATHROOMS (I.E. BATHING TUBS/WHIRLPOOLS) KITCHENS, LAUNDRY ROOMS, ETC. (TYPICAL) CONTRACTOR TO PROVIDE ADEQUATE BLOCKING AND BRIDGING BETWEEN FLOOR JOISTS AS REQUIRED (TYPICAL) CONTRACTOR TO PROVIDE ADEQUATE HEADERS OVER ALL WINDOWS AND DOORS ON EXTERIOR LOAD-BEARING WALLS (TYP.) SEE TABLE R401.4.1 FOR PRESUMPTIVE LOAD-BEARING VALUES OF FOUNDATION MATERIALS SEE TABLE R402.2 FOR MINIMUM SPECIFIED COMPRESSIVE STRENGTH OF CONCRETE GEOTECHNICAL ENGINEERING SERVICES (ON EXISTING CONDITIONS AND PROPOSED CONSTRUCTION) TO BE BY OTHERS

VERIFY RIDGE SIZES IN FIELD (LENGTH TO EXCEED PLUM CUT OF RAFTER) 2 x 10 RAFTERS @ 16" O.C. (SPF # 2 OR BETTER) 2 x 12 RAFTERS @ 16" O.C. (SPF # 2 OR BETTER) NOTE:
UPGRADE TO STRONGER WOOD SPECIES IF
SPAN LENGTH EXCEEDS LOCAL CODE
-EXACT RAFTER, SIZE, GRADE, & SPACINGS TO
BE DETERMINED BY THE TOWN OR CITIES
GROUND SNOW LOAD. (HAVERHILL @ 50 PSF)
-REFER TO TABLES R802.5.1(1)
-R802.5.1(8) IN THE 2015 IRC 2 x 8 CLG. JSTS. BETWEEN ALL RAFTERS 2 x 8 COLLAR TIES BETWEEN ALL RAFTERS 235# ASPHALT SHINGLES ON 15# ROOFING FELT ON 1/2" OR 5/8" EXT. GRADE PLYWOOD SHEATHING ICE & WEATHER SHIELD AT RAFTER TAILS & VALLEYS

EAVE/RAKE: METAL DRIP EDGE 1x4 PINE BLOCKING (SUB-FASCIA) 1x8 PINE BD. FASCIA 3/8" AC EXT. GD. PLYWD SOFFIT W/2" CONT. LOUVERED VENT (SOFFIT ONLY) EXTERIOR WALL CONSTRUCTION: 2 x 6 WOOD STUDS @ 16" O.C. W/ TYVEK (OR EQUAL) WIND BARRIER AND MINIMUM 7/16" PERFORMANCE CATEGORY WOOD STRUCTURAL SHEATHING

2 x 6 DOUBLE TOP PLATE 2 x 6 SINGLE BOTTOM PLATE

ROOF CONSTRUCTION:

CONTRACTOR TO PROVIDE ADEQUATE HEADERS OVER ALL WINDOWS AND DOORS ON EXTERIOR LOAD-BEARING WALLS (TYP.)

INTERIOR CONSTRUCTION: 2 x 4 WOOD STUDS @ 16" O.C.

SINGLE TOP PLATE (DBL. ON LD. BRG. WALLS ONLY) 2 x 4 SINGLE BOTTOM PLATE

1/2" GYPSUM WALL BOARD EA. SIDE STUD -MOISTURE-RESISTANT / FIRE-RATED WHERE REQUIRED

1/2" G.W.B. ON 1x3 WOOD STRAPPING @ 16"O.C.-MOISTURE-RESISTANT / FIRE-RATED WHERE REQUIRED

2x12 STAIR STRINGERS @ 12" O.C.

FLOOR CONSTRUCTION: 2x10 FLOOR JOISTS @ 12" & 16" O.C. W/ 3/4" TONGUE & GROOVE PLYWD. GLUED & NAILED (TYP. U.O.N.) -SEE FLOOR PLANS FOR FRAMING DIRECTION/ SPACING NOTATION MARKERS BUILT-UP BEAMS SIZED BY CONTRACTOR

DOUBLE UP FLOOR JOISTS @ LOCATIONS OF NON-LOAD BEARING WALLS AND UNDER ALL BATHING TUBS/WHIRLPOOLS & KITCHENS (TYP.)

FOUNDATION CONSTRUCTION:

10" CONCRETE FOUNDATION WALL WITH (2) 2x6 SILL PLATES (K.D. ON P.T.) WITH SILL SEAL ON TOP OF CONTINUOUS 1'-8" x 10" CONCRETE FOOTING - REINFORCEMENT BY OTHERS 10" CONC. FROST WALLS (WHERE SHOWN) TO BE 48" BELOW GRADE ON TOP OF CONTINUOUS 1'-8" x 10" CONCRETE FOOTING -

REINFORCEMENT BY OTHERS PROVIDE 3 1/2" DIA. STEEL COLUMNS OVER SIZED CONC. FOOTINGS AS REQ D FOR BEAMS SHOWN ON PLAN

REFER TO SECTION R404.1.3.2 FOR HORIZONTAL AND VERTICAL REINFORCEMENT FOR FOUNDATION WALLS

PROVIDE MATCHING CORNER DOWELS LAP 50 BAR DIAMETERS (TYPICAL)

INSULATION

WALLS: R-20 CAVITY INSULATION OR R-13 PLUS R-5 FLOOR: R-30 OR INSULATION SUFFICIENT TO FILL JOIST CAVITY CEILING: R-49 (ZONE 6) - HOWEVER, IF MAINTAINING THE FULL R VALUE OVER THE PLATES (RAISED), R-38

THESE VALUES DO NOT NEED TO BE FOLLOWED IF FOLLOWING THE ERI (HERS RATING) PATH TO COMPLIANCE

MOISTURE VAPOR RETARDERS SHALL BE INSTALLED IN ACCORDANCE WITH THE REQUIREMENTS SET FORTH IN THE 2015 I.R.C. SECTIONS R318.1, AND R702.7 MOISTURE CONTROL WHILE IT IS OUR INTENT TO DELIVER OUR SERVICES FR ERROR. OMISSION OR OVERSIGHT WE WILL ADMIT TO E HUMAN. AND THEREFORE FSM DRAWINGS LLC. ACTING AS THE DEAPTING COMPAN, WILL RELY ON THE EXPERICANTRACTOR USING THESE PLANS TO THOROUGHLY REVEOUNTSIONAL ACCURACY, COMPLETENESS AND APPROPRIATENESS. THE CONTRACTOR USING THESE PLA ASSUMES ALL REPONDIBILITY FOR THEM AND WILL IF DEEMS NECESSARY HIRE A LICENSED PROFESSIONAL EN ASSIST IN THE REVIEW.

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